CONCEPT ENGINEERING PLANS OF 'PROPOSED SUBDIVISION' STAGE 6N & 7N (REF DA No. 11-2921) OF LOT 500, D.P. 1228344 RAYMOND TERRACE ROAD, CHISHOLM



INDEX OF DRAWINGS

| DRAWING No. | NAME | | | | | | |
|---|--|--|--|--|--|--|--|
| 50031(6N & 7N)-CENG-001 50031(6N & 7N)-CENG-002 | COVER SHEET, INDEX OF DRAWINGS & LOCALITY SKETCH OVERALL SITE PLAN & GENERAL NOTES | | | | | | |
| 50031(6N & 7N)-CENG-101 | DETAIL PLAN - SHEET 1 | | | | | | |
| 50031(6N & 7N)-CENG-102 | DETAIL PLAN - SHEET 2 | | | | | | |
| 50031(6N & 7N)-CENG-201 | ROAD LONGITUDINAL SECTION - BILLABONG PARADE - SHEET 1 | | | | | | |
| 50031(6N & 7N)-CENG-202 | ROAD LONGITUDINAL SECTION - BILLABONG PARADE - SHEET 2 | | | | | | |
| 50031(6N & 7N)-CENG-221 | TYPICAL ROAD PROFILES & KERB DETAILS | | | | | | |
| 50031(6N & 7N)-CENG-501 | SITE REGRADE PLAN - SHEET 1 | | | | | | |
| 50031(6N & 7N)-CENG-502 | SITE REGRADE PLAN - SHEET 2 | | | | | | |
| 50031(6N & 7N)-CENG-601 50031(6N & 7N)-CENG-602 50031(6N & 7N)-CENG-611 | EROSION & SEDIMENT CONTROL PLAN - SHEET 1 EROSION & SEDIMENT CONTROL PLAN - SHEET 2 EROSION & SEDIMENT CONTROL DETAILS & NOTES | | | | | | |



NOT FOR CONSTRUCTION

REV. DATE AMENDMENT DESIGN DRAWN CHECKED APPROVED SCALES PROPERTY DESCRIPTION PROJECT PROPOSED SUBDIVISION "DRAFT LOT 5" OF LOT 2 IN D.P.1090329 & LOT 600 5 Pioneer Avenue, P.O. Box 3717, IN D.P.1240613 & "DRAFT LOT 6" OF LOT 3 IN Tuggerah N.S.W. 2259 COVER SHEET, INDEX OF DRAWINGS D.P.1090329 & LOT 728 IN D.P.1240614 one: (02) 4305 4300 x: (02) 4305 4399 RAYMOND TERRACE ROAD, CHISHOLM & LOCALITY SKETCH Property Group 50031(6N & 7N) - CENG ALL DIMENSIONS ARE IN METRES. DO NOT SCALI DESIGN FILE S:\50031\50031(6)\Design\12D\STAGE 6 ENG DESIGN\STAGE_6_ENG_DESIGN.project Plotted By: Michael Vella Plot Date: 20/01/21 11:03:12AM Cad File: S:\50031\50031(6N 7N)\DRAWNGS\FNGNFFRING\CIVIL\CFNG\50031(6N & 7N)-CFNG-001.DW

LEGEND SITE BOUNDARY
PROPOSED LOT BOUNDARY
EXISTING LOT BOUNDARY FUTURE LOT BOUNDARY

GENERAL NOTES: -

- ALL WORKS SHALL BE CARRIED OUT IN ACCORDANCE WITH THE APPROVED PLANS, SUBJECT TO MAITLAND CITY COUNCIL'S "MANUAL OF ENGINEERING STANDARDS".
- 2. ALL LEVELS SHALL BE OBTAINED FROM ESTABLISHED BENCHMARKS TO AUSTRALIAN HEIGHT DATUM (A.H.D.)
- 3. TRAFFIC CONTROL MEASURES SHALL BE IN ACCORDANCE WITH THE RMS DOCUMENT "TRAFFIC CONTROL AT WORKSITES".
- ALL TREES WITHIN THE ALLOTMENT AND RESERVES (OTHER THAN ROAD RESERVES) SHALL BE RETAINED, UNLESS OTHERWSE NOMINATED BY THE APPROVED LANDSCAPE PLAN. REMOVAL OF TREES FOR THE ESTABLISHED OF FIRE-BREAKS SHALL BE CARRIED OUT IN CONSULTATION WITH THE FIRE CONTROL OFFICER AND/OR COUNCIL'S ENVIRONMENTAL OFFICER.
- 5. POINT'S OF CONFLICT BETWEEN NEW CONSTRUCTION AND EXISTING UTILITY SERVICE MAINS SHALL BE IDENTIFIED, EXPOSED AND REPORTED TO THE PROJECT MANAGER PRIOR TO CONSTRUCTION. SERVICE CONDUITS SHALL BE LAID IN POSITIONS AS APPROVED BY THE RELEVANT AUTHORITY.
- 6. PROVISION SHOULD BE MADE FOR SUITABLE PROTECTION OF THE EXISTING ROAD PAVEMENTS, KERB AND GUTTER AND FOOTPATH FORMATION. VEHICULAR ACCESS TO ALL SERVICES TO ADJOINING PROPERTIES AFFECTED BY CONSTRUCTION WORKS, SHALL BE MAINTAINED AT ALL TIMES.
- 7. TOPSOIL 150mm THICK SHALL BE APPLIED TO ALL FOOTPATHS AND FILLED AREAS. WHERE TURF IS NOT REQUESTED, ALL EXPOSED TOPSOIL SHALL BE SEEDED IMMEDIATELY UPON COMPLETION OF THE SOIL SPREADING OPERATION. TURF TO BE PLACED FULL WIDTH BETWEEN KERB AND FOOTPATH.
- 8. ALL SILT CONTROL MEASURES SHALL BE PLACED PRIOR TO THE COMMENCEMENT OF EARTHWORKS. SUCH MEASURES SHALL BE SUBJECT TO FURTHER ADDITIONS, WHERE CONSIDERED NECESSARY, AS DIRECTED BY THE PROJECT MANAGER OR COUNCIL, DURING THE PROGRESSIONS OF WORKS. ALL FINAL EROSION PREVENTION MEASURES INCLUDING ESTABLISHMENT OF GRASS SHALL BE COMPLETED PRIOR TO THE "FINAL" INSPECTION.
- SUBSOIL DRAINS SHALL BE PROVIDED AS SHOWN ON PLANS, ADDITIONAL DRAINS SHALL BE PROVIDED WHERE CONSIDERED NECESSARY, BY COUNCIL OR A GEOTECHNICAL ENGINEER.
- 10. ALL MATERIALS AND PRODUCTS FOR INSTALLATION AND CONSTRUCTION SHALL COMPLY WITH AUSTRALIAN STANDARDS. MONITORING TESTING ("STRING LINE" AND "ROLL") WHERE SPECIFIED BY COUNCIL'S MANUAL OF ENGINEERING STANDARDS, TO BE PERFORMED BY COUNCIL, SHALL BE ARRANGED 24 HOURS IN ADVANCE. WHERE A COUNCIL OFFICER IS NOT AVAILABLE, A GEOTECHNICAL ENGINEER MAY PERFORM SUCH TESTS.
- 11. ALL FILL WITHIN LOTS INCLUDING BATTERS SHALL BE PLACED IN ACCORDANCE WITH AS 3798 TO LEVEL 1 INSPECTION AND TESTING.
- 12. PAVEMENT DESIGN HAS BEEN BASED ON SUBGRADE INVESTIGATION CARRIED OUT BY CARDNO GEOTECH SOLUTIONS.
- 13. THE INSPECTION, SUPERVISION AND REPORTING REQUIREMENTS OF A SUITABLY QUALIFIED ECOLOGIST REGARDING THE REMOVAL AND RELOCATION OF ANY THREATENED FAUNA SPECIES SHALL BE UNDERTAKEN AS PER RELEVANT CONDITIONS OF

ORIGIN OF LEVELS
BENCH MARK
P.M. 83572
E 371190.202
N 6373751.025
R.L. 19.989 A.H.D.



NOT FOR CONSTRUCTION

REV. DATE AMENDMENT DESIGN DRAWN CHECKED APPROVED SCALES adw Fax: ohnson ABN 62 129 445 398 DESIGN FILE S:\50031\50031(6)\Design\12D\STAGE 6 ENG DESIGN\STAGE_6_ENG_DESIGN.project ALL DIMENSIONS ARE IN METRES. DO NOT SCAL

SCALE 1:1250

Central Coast 5 Pioneer Avenue, P.O. Box 3717, Tuggerah N.S.W. 2259 Phone: (02) 4305 4300 (02) 4305 4399 email: coast@adwjohnson.cor

Property Group


PROPERTY DESCRIPTION "DRAFT LOT 5" OF LOT 2 IN D.P.1090329 & LOT 600 IN D.P.1240613 & "DRAFT LOT 6" OF LOT 3 IN D.P.1090329 & LOT 728 IN D.P.1240614 RAYMOND TERRACE ROAD, CHISHOLM


PROJECT PROPOSED SUBDIVISION PLAN TITLE

OVERALL SITE PLAN & GENERAL NOTES

50031(6N & 7N) - CENG -Α

Plotted By, Michael Vella Plot Date: 20/01/21 11:03:14AM Cad File: S:\50031\50031(6N 7N)\DRAWINGS\ENGINEERING\CIVIL\CENG\50031(6N & 7N)-CENG-002.DWG

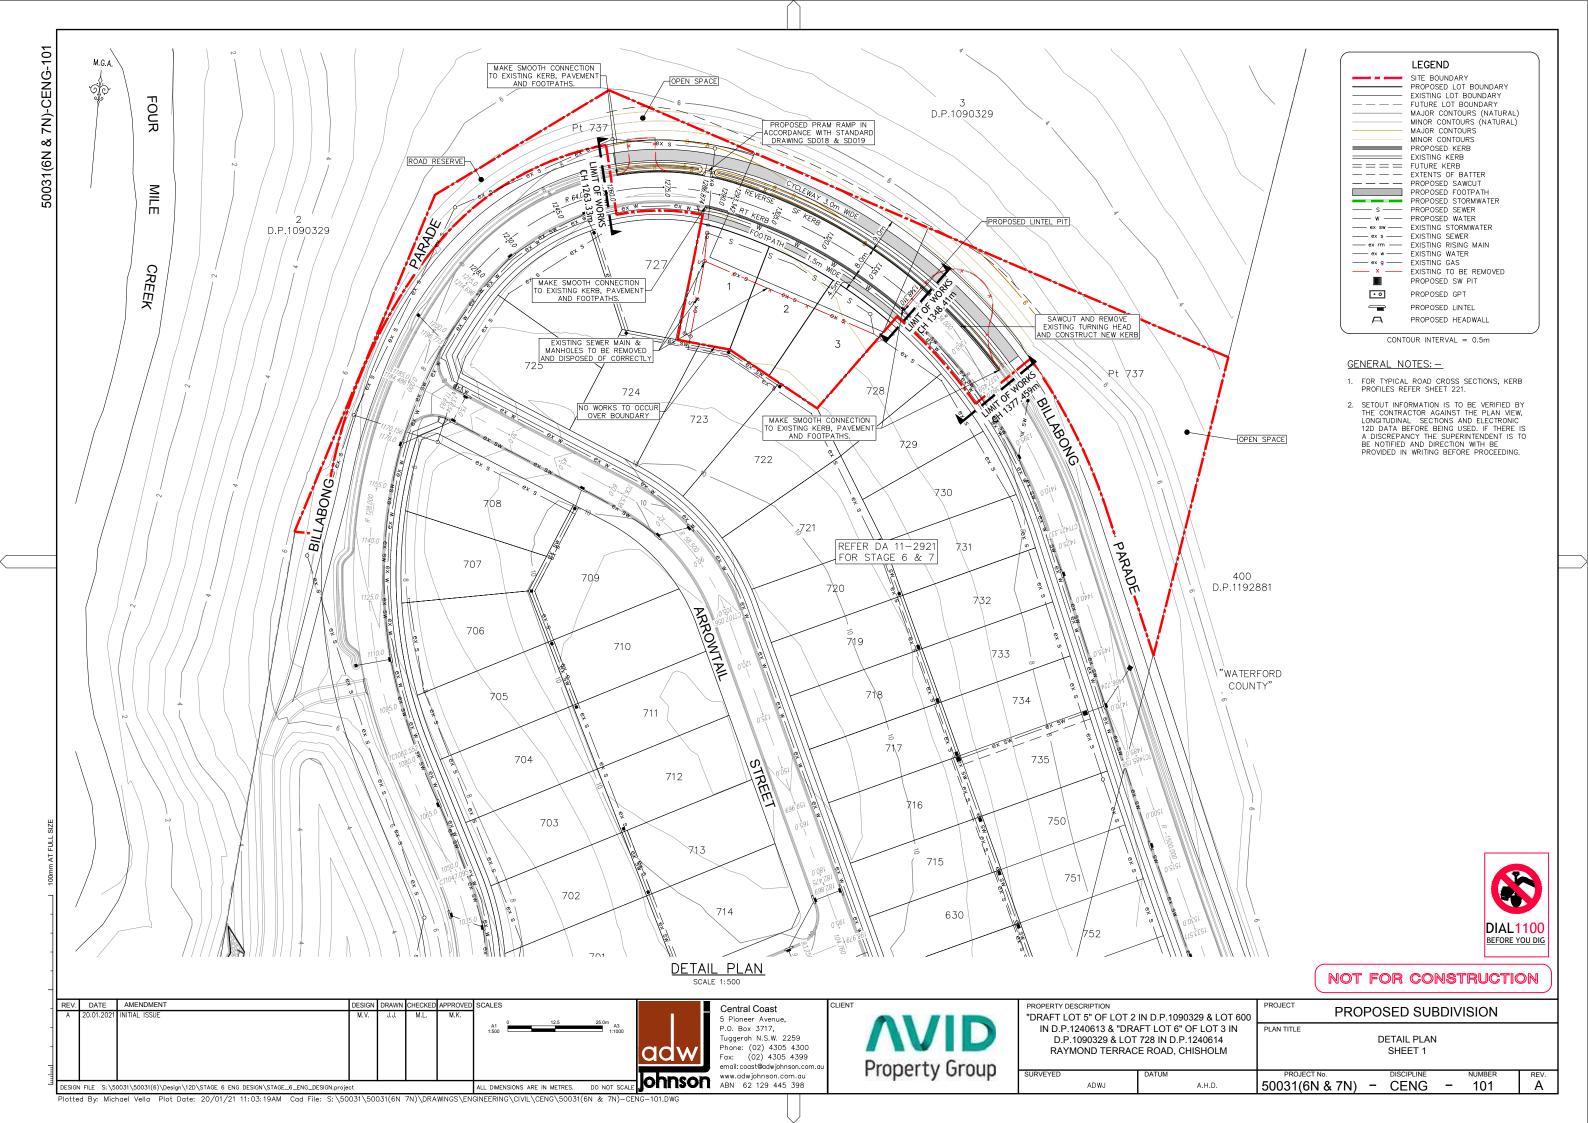

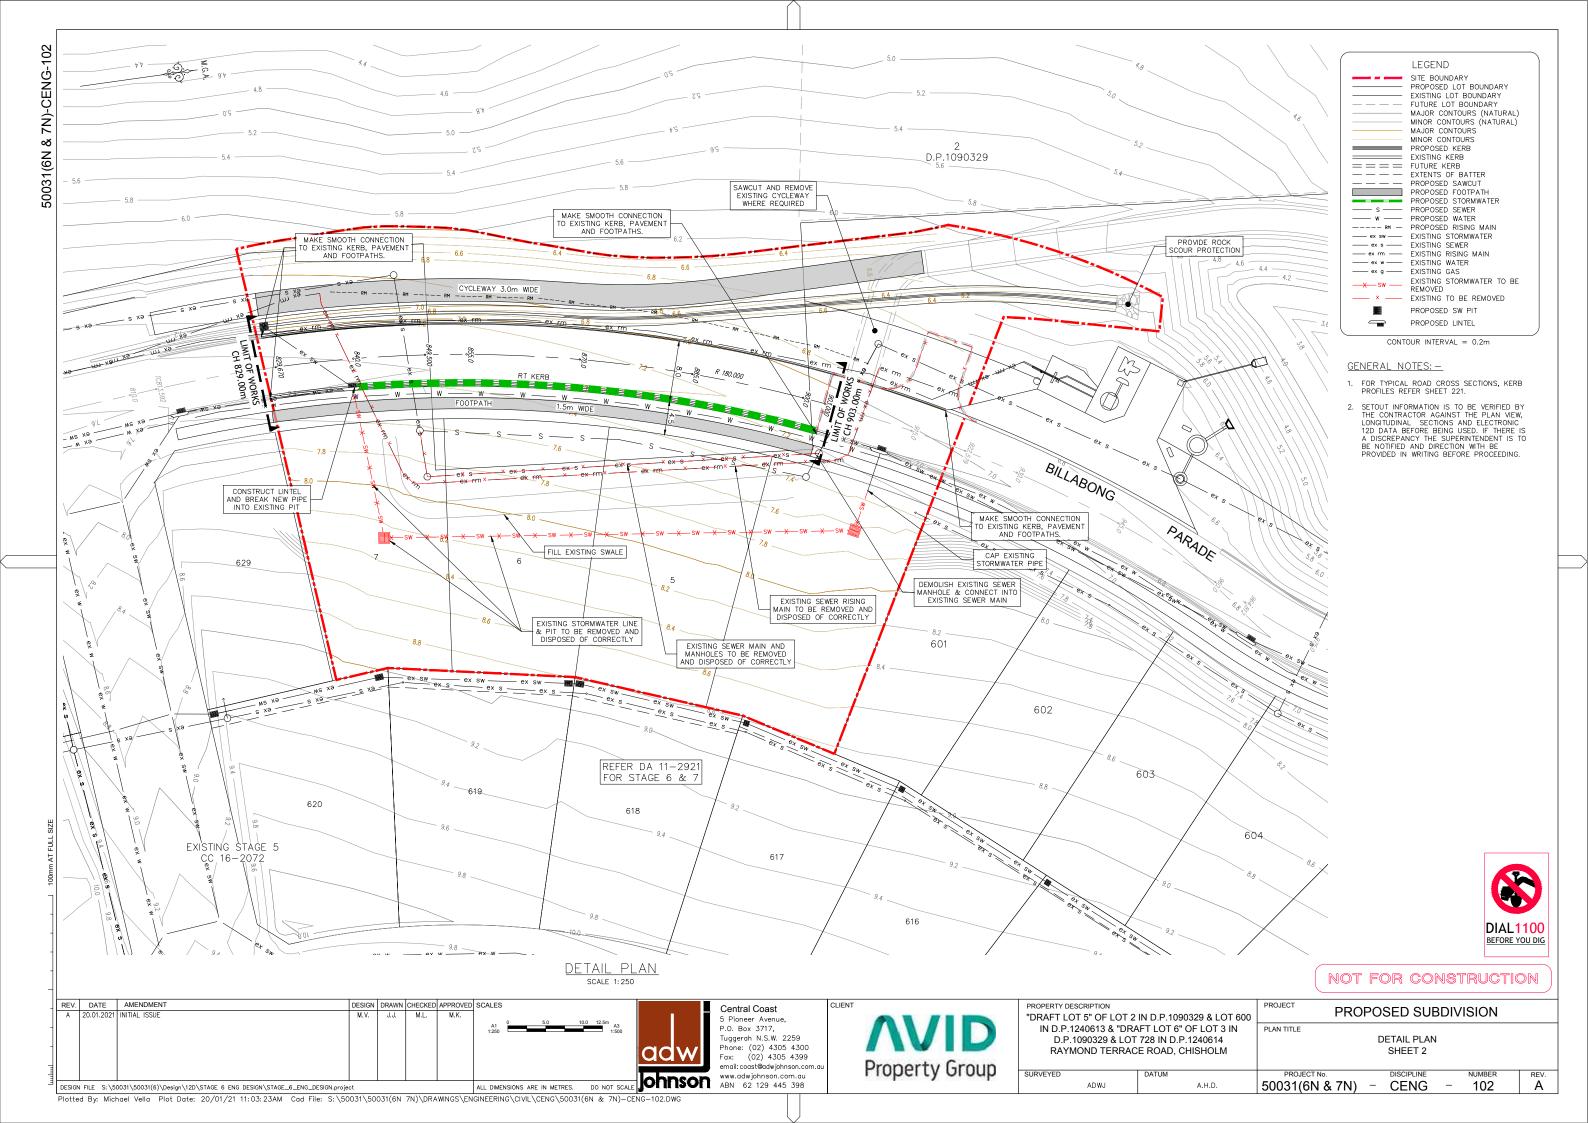

REV. DATE AMENDMENT

DESIGN FILE S:\50031\50031(6)\Design\12D\STAGE 6 ENG DESIGN\STAGE_6_ENG_DESIGN.project

Plotted By. Michael Vella Plot Date: 20/01/21 11:03:26AM Cad File: S:\50031\50031(6N 7N)\DRAWINGS\ENGINEERING\CIVIL\CENG\50031(6N & 7N)-CENG-201.DWG

ALL DIMENSIONS ARE IN METRES. DO NOT SCALE JOHNSON ARE IN METRES. DO NOT SCALE JOHNSON ARE IN METRES.

Central Coast
5 Pioneer Avenue,
P.O. Box 3717,
Tuggerah N.S.W. 2259
Phone: (02) 4305 4300
Fox: (02) 4305 4399
email: coast@adwjohnson.com

Property Group

PROPERTY DESCRIPTION
"DRAFT LOT 5" OF LOT 2 IN D.P.1090329 & LOT 600 IN D.P.1240613 & "DRAFT LOT 6" OF LOT 3 IN D.P.1090329 & LOT 728 IN D.P.1240614 RAYMOND TERRACE ROAD, CHISHOLM

PROJECT PROPOSED SUBDIVISION PLAN TITLE

NOT FOR CONSTRUCTION

DIAL1100 BEFORE YOU DIG

REV.

ROAD LONGITUDINAL SECTION BILLABONG PARADE SHEET 1 PROJECT No. DISCIPLINE 50031(6N & 7N) - CENG

| | | | | | | | | MAKE S CONNEC' EXISTING F | SMOOTH TION TO PAVEMENT | | | | | | | LIMIT OF WORK CH 918.264m | MAI CON EXISTI | IKE SMOOTH INECTION TO ING PAVEMENT | , — – | |
|---|-----------|------|------|------|----------|------|------|---------------------------------|-------------------------------|---------------|------|------|------|--------|-------|---------------------------|----------------------|---|--------|--------------------------|
| K VALUE DESIGN GRADE VERTICAL GEOMETRY HORIZONTAL GEOMETRY | R 211m > | | | | EXISTING | | | | | -0.50% | | | | R 180m | | | | EXISTIN | 1G | 33.3 40m VC R -67m |
| DESIGN LEVEL 8 | 2 2 | 41. | 90: | 66. | 16. 84 | .76 | 69 | <u> </u> | .52 | 94. | .39 | .31 | 24 | 91: | 60: | 10. | 46: | 98. | .76 | 6.71 |
| EXISTING SURFACE (ES) | 8.21 8.20 | 8.14 | 8.06 | 7.99 | 7.91 7 | 7.76 | 7.69 | 0 | 7.52 7. | 7.42 7 | 7.16 | 7.06 | 7.07 | 7.1 | 7.14 | 7.15 7 7.13 7 | 7 | 6.92 | 7.45 6 | 5.49 |
| -CUT \ +FILL ES to DESIGN | 0 0 | 0 | 0 | 0 | 0 0 | 0 | 0 | 0 | 0 | 0.04 | 0.23 | 0.25 | 0.17 | 90.0 | -0.06 | -0.14 | -0.06 | -0.05 | -0.66 | 1.54 |
| CHAINAGE | 675 | 069 | 705 | 720 | 735 | 765 | 780 | 25 | 813.59 | 825 829.67 | 840 | 855 | 870 | 885 | 006 | 915 918.26 | 930 | 945 | 960 | 975 |

LONGITUDINAL SECTION — BILLABONG PARADE

HORIZONTAL SCALE 1:500

VERTICAL SCALE 1:100

K VALUE DESIGN GRADE

VERTICAL GEOMETRY HORIZONTAL GEOMETRY

DATUM -1.0 DESIGN LEVEL

SURFACE (ES) -CUT \ +FILL ES to DESIGN

CHAINAGE

REV. DATE AMENDMENT

ALL DIMENSIONS ARE IN METRES. DO NOT SCALE JOHNSON. ARE IN METRES. DO NOT SCALE JOHNS DESIGN FILE S:\50031\50031(6)\Design\12D\STAGE 6 ENG DESIGN\STAGE_6_ENG_DESIGN.project

R 128m

Central Coast
5 Pioneer Avenue,
P.O. Box 3717,
Tuggerah N.S.W. 2259 Phone: (02) 4305 4300 Fax: (02) 4305 4399 Property Group

PROPERTY DESCRIPTION "DRAFT LOT 5" OF LOT 2 IN D.P.1090329 & LOT 600 IN D.P.1240613 & "DRAFT LOT 6" OF LOT 3 IN D.P.1090329 & LOT 728 IN D.P.1240614 RAYMOND TERRACE ROAD, CHISHOLM

R 134m

PROJECT PROPOSED SUBDIVISION PLAN TITLE

NOT FOR CONSTRUCTION

DIAL1100 BEFORE YOU DIG

REV.

ROAD LONGITUDINAL SECTION BILLABONG PARADE SHEET 2

50031(6N & 7N) - CENG

Plotted By. Michael Vella Plot Date: 20/01/21 11:03:28AM Cad File: S:\50031\50031(6N 7N)\DRAWINGS\ENGINEERING\CIVIL\CENG\50031(6N & 7N)-CENG-202.DWG


LONGITUDINAL SECTION — BILLABONG PARADE VERTICAL SCALE 1:100

rest R.L. 8.452m

| PAVEMENT COMPOSITIONS — FLEXIBLE PAVEMENTS | | | | | | | |
|---|----------------------------|--|--|--|--|--|--|
| ROAD SECTION | ALL ROADS | | | | | | |
| WEARING COURSE ⁽¹⁾ (mm) | 30(AC10) | | | | | | |
| BASECOURSE (mm) | 160 | | | | | | |
| SUBBASE(mm) | 125 | | | | | | |
| TOTAL THICKNESS(mm) | 315 | | | | | | |
| SUBGRADE MATERIAL | FILL/SANDSTONE | | | | | | |
| SELECT SUBGRADE (CBR 15%) | 300*(4) | | | | | | |
| SUBGRADE DESIGN CBR | 8% | | | | | | |
| DESIGN TRAFFIC | 1.5 x 10 ⁶ DESA | | | | | | |

PAVEMENT NOTES:

- 1 WITH 7mm PRIMER SEAL
- 2. PAVEMENT BASED ON 'REPORT ON GEOTECHNICAL INVESTIGATION' HARVEST ESTATE STAGE 6/7 CARDNO GEOTECH SOLUTIONS
- CONFIRM SUBGRADE CONDITION WITH GEOTECHNICAL ENGINEER PRIOR TO PLACEMENT OF SELECT MATERIALS.
- 4. WHEN SUBGRADE IS CLAY OR FILL

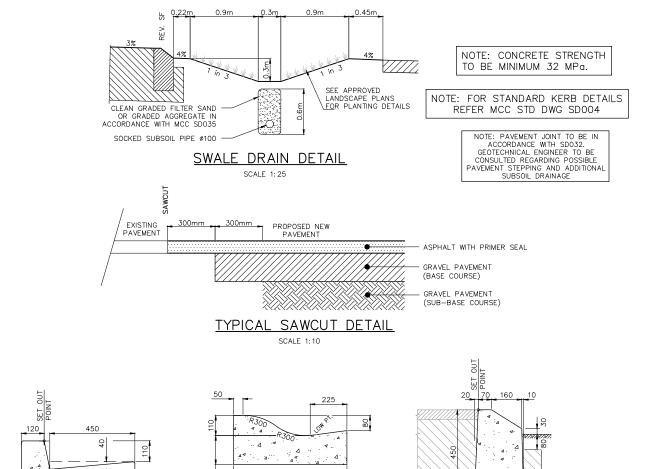

ROLL KERB & GUTTER

(MODIFIED RT) SCALE 1:10



NOT FOR CONSTRUCTION

260


REVERSE SF KERB





STANDARD KERB & GUTTER


(MODIFIED SA KERB MCC)
SCALE 1:10

Plotted By. Michael Vella Plot Date: 20/01/21 11:03:30AM Cad File: S:\50031\50031(6N 7N)\DRAWINGS\ENGINEERING\CIVIL\CENG\50031(6N & 7N)-CENG-221.DWG

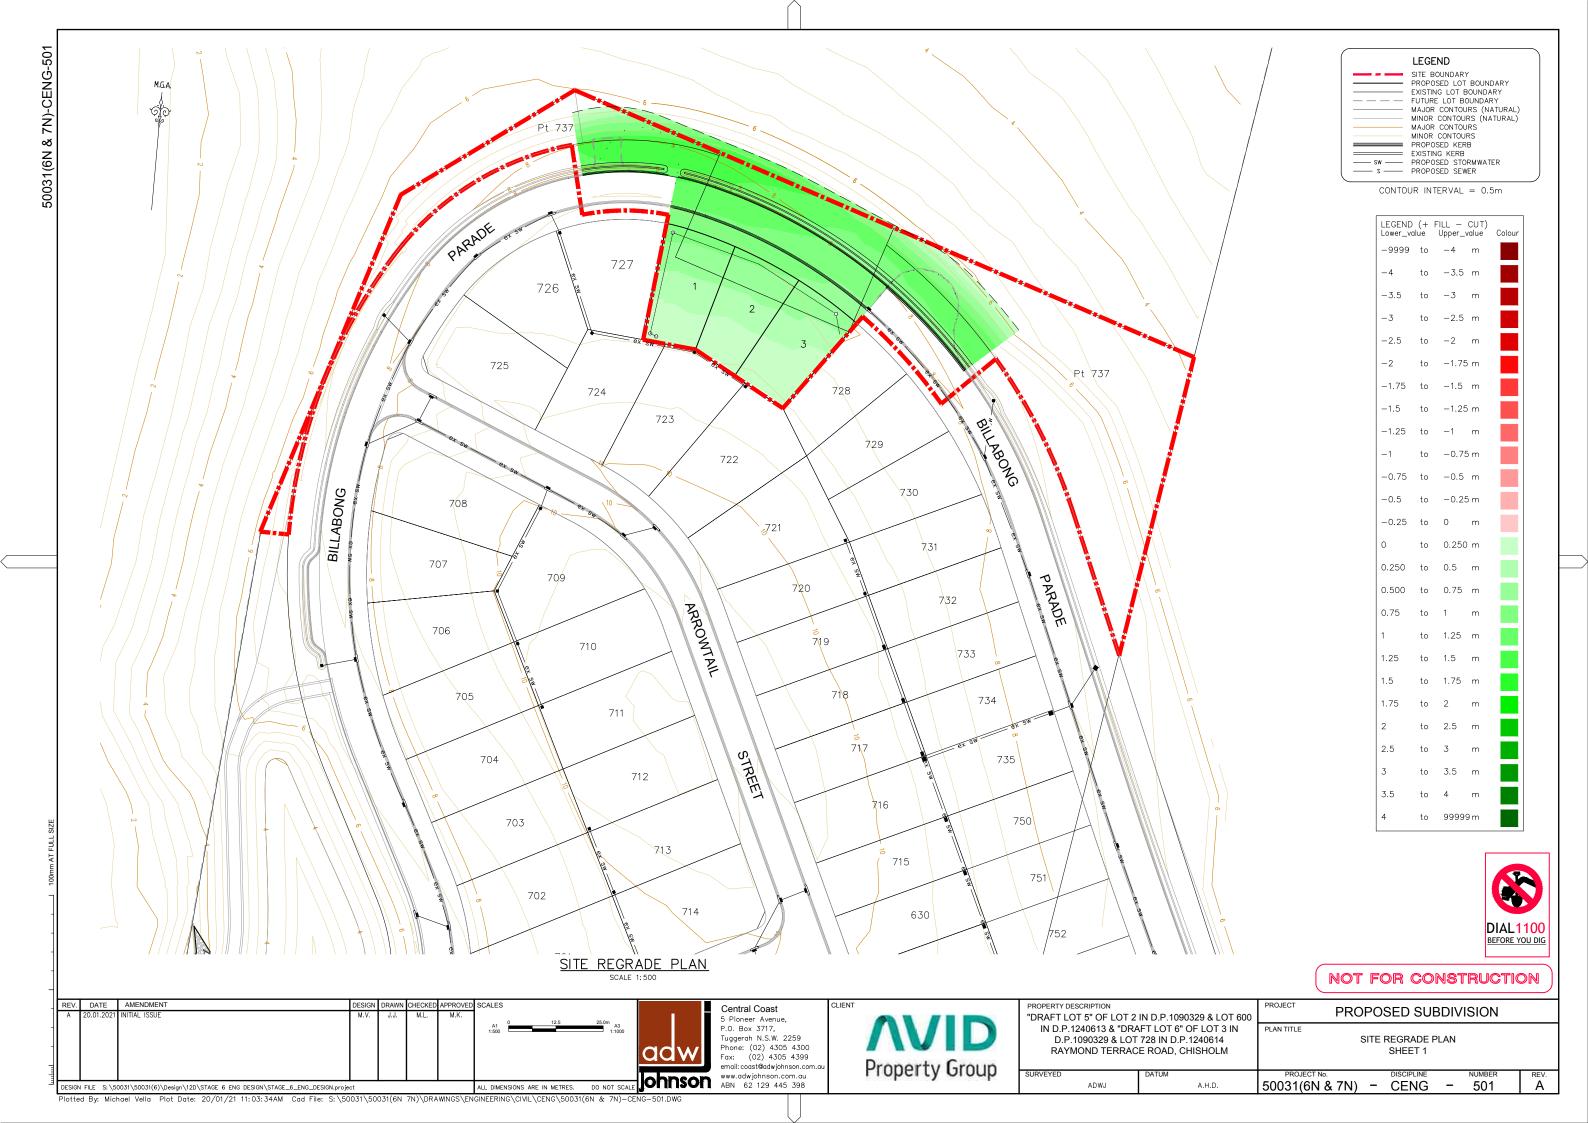


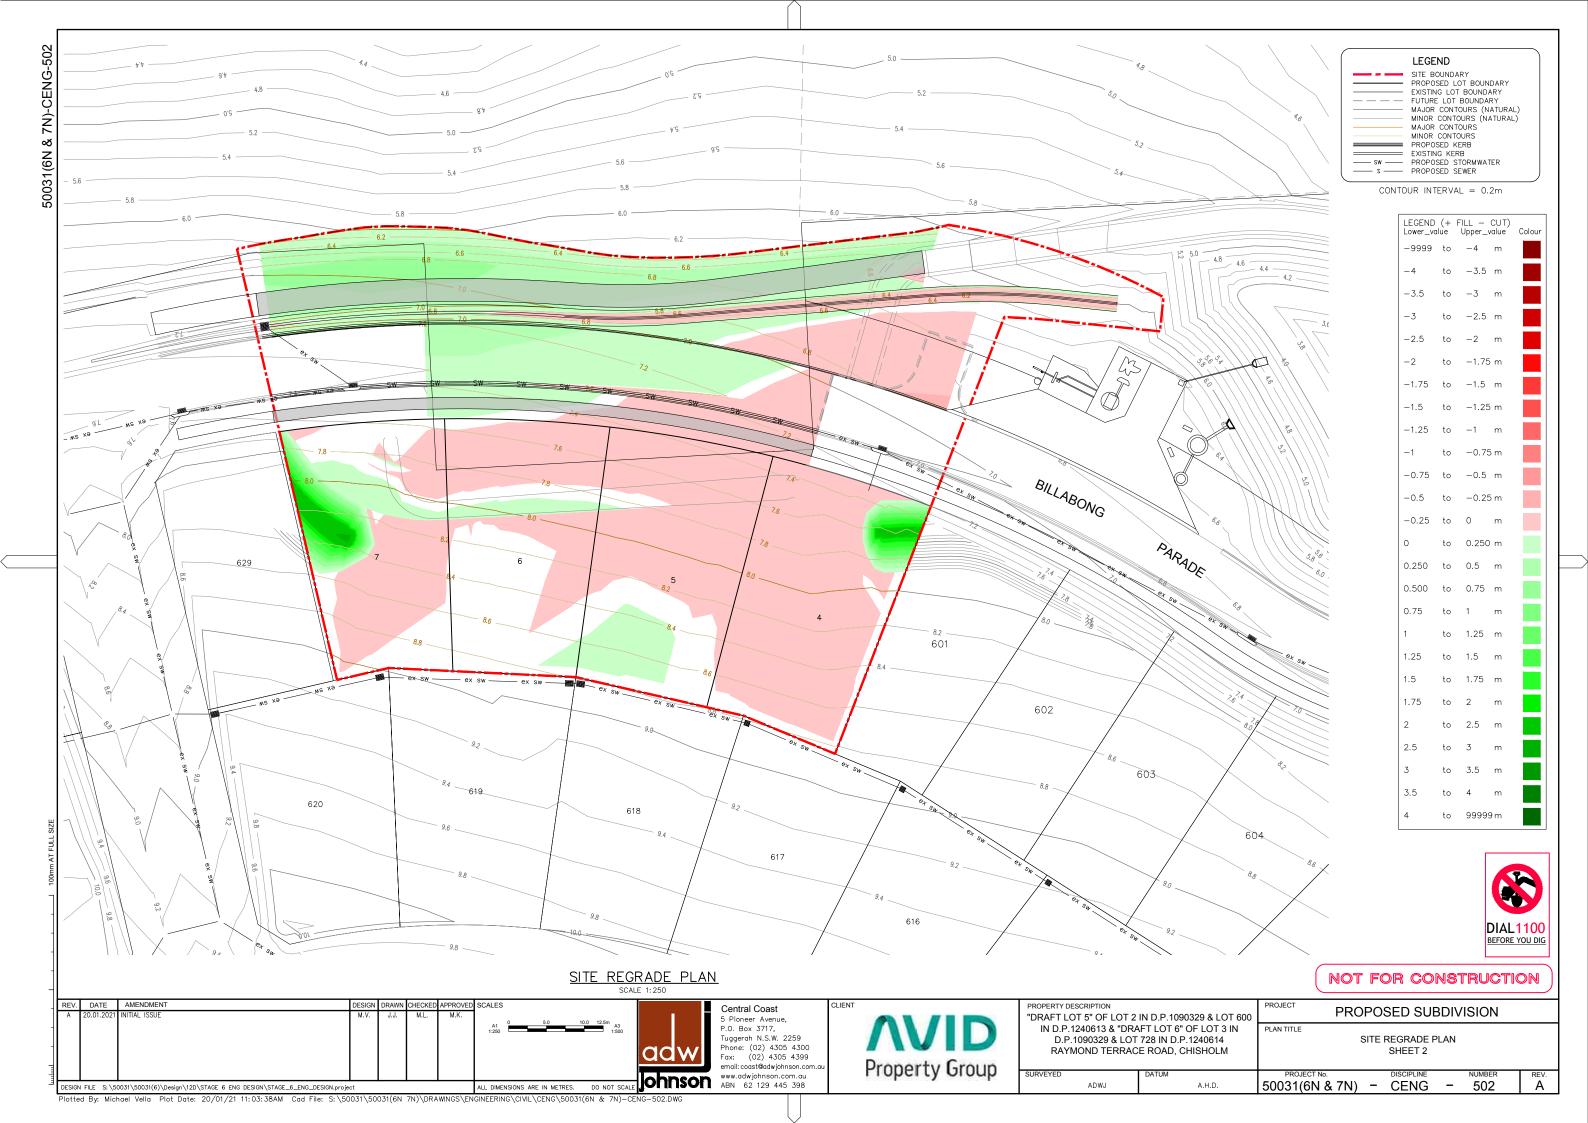

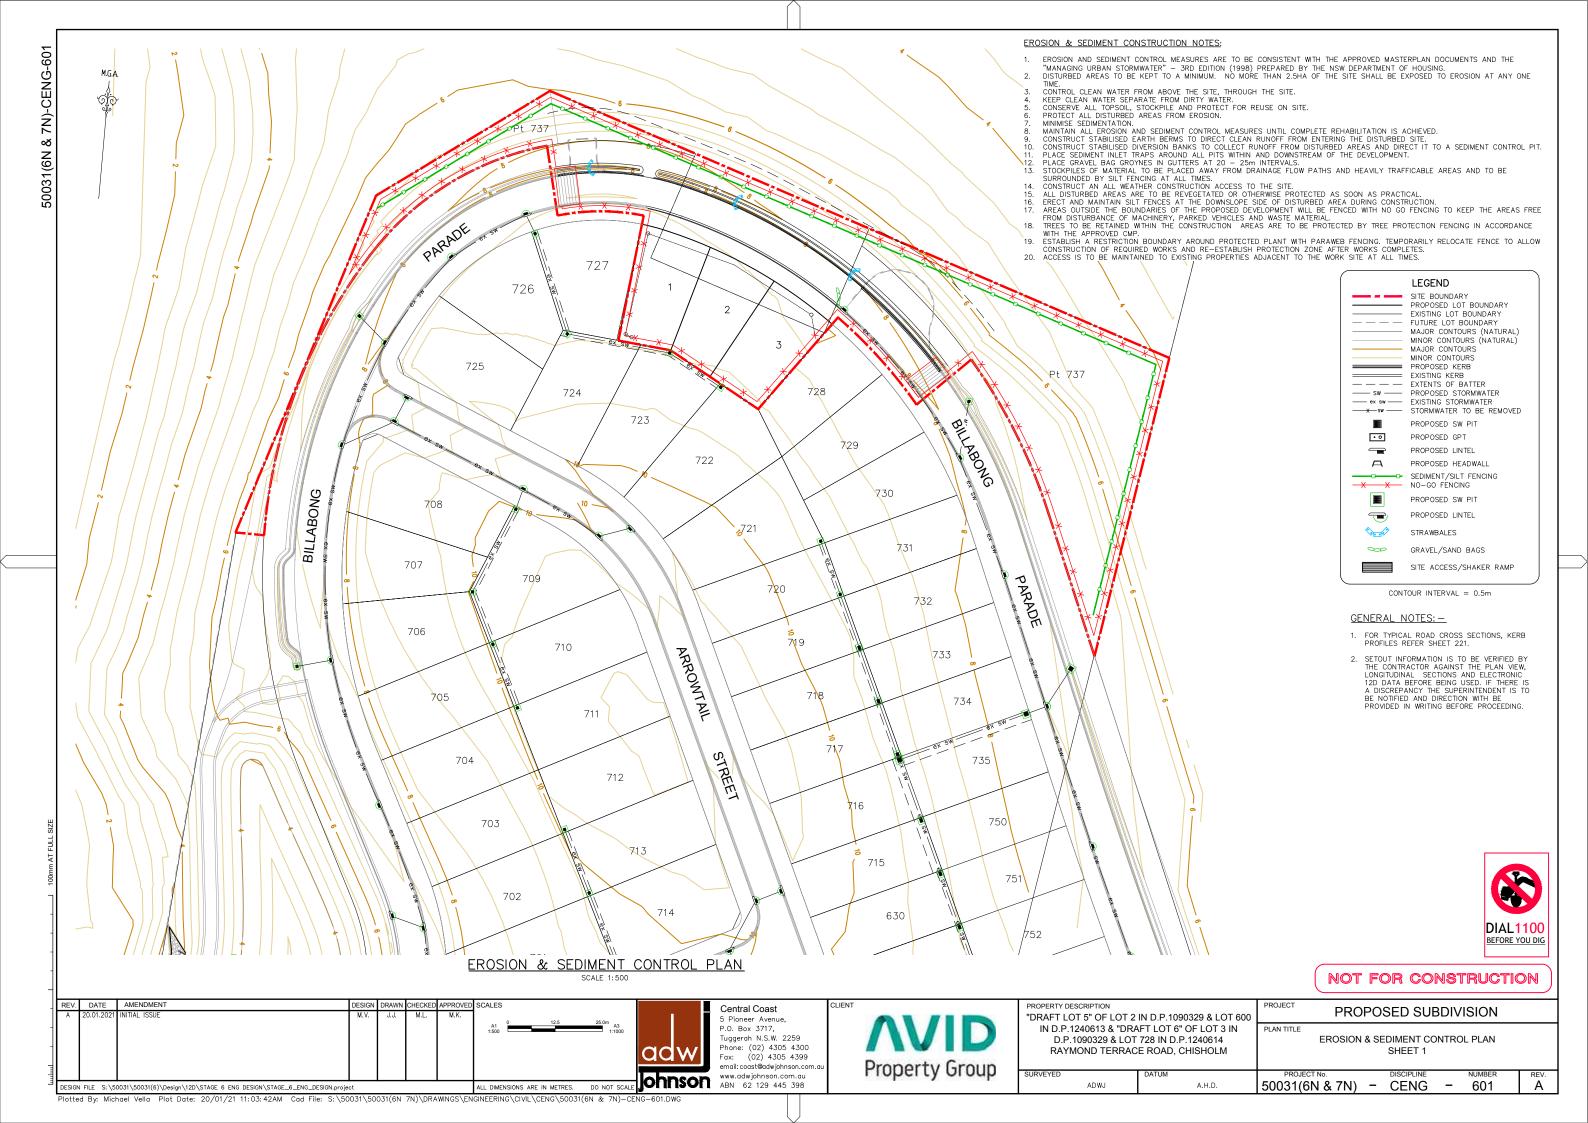


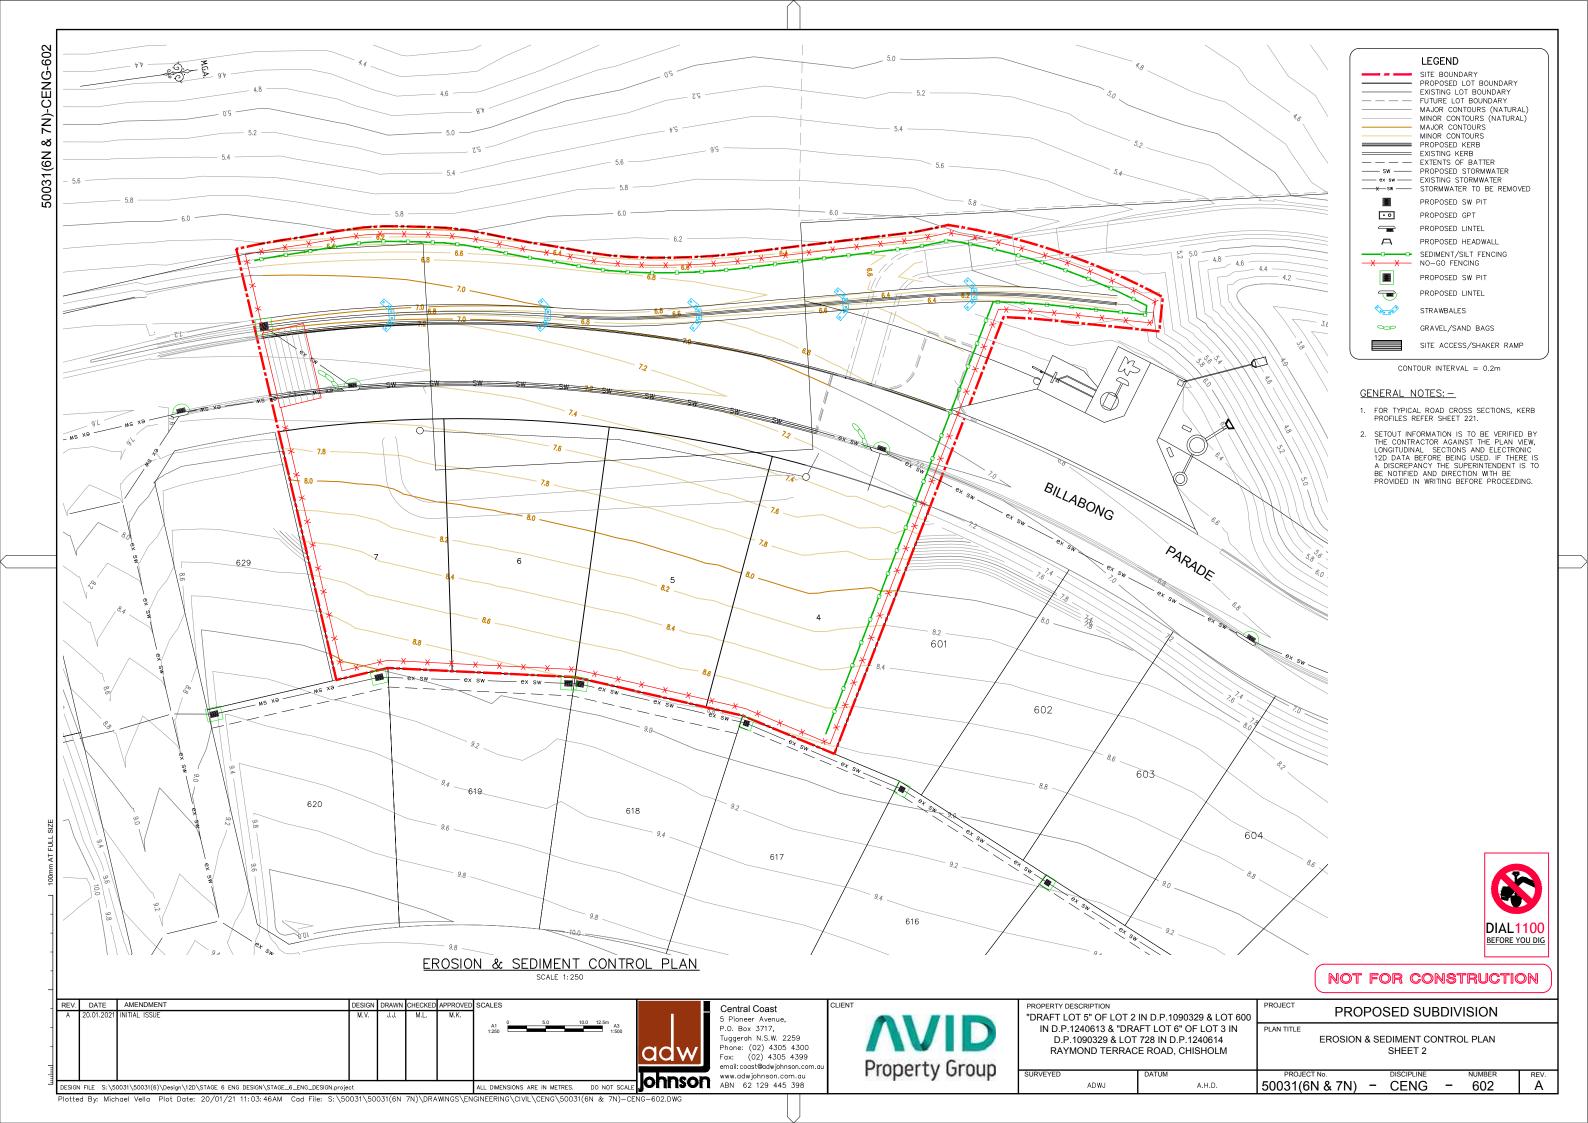


HAYBALE & GEOTEXTILE FENCE

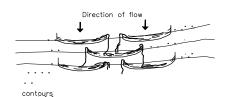


SILT FENCE CONFIGURATION

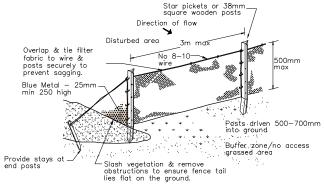


SILT FENCE

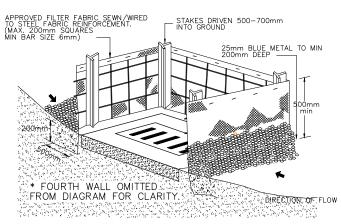


STORM INLET SEDIMENT TRAP

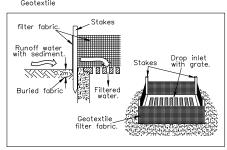

GEOTEXTILE FILTER FABRIC DROP INLET SEDIMENT TRAP

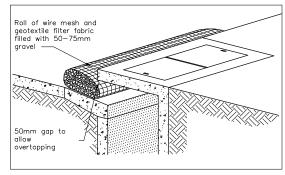

PORTABLE GRAVEL KERB INLET SEDIMENT TRAP

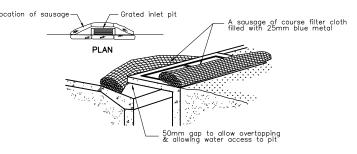

KERB INLET CONTROL - LOW POINT



NOT FOR CONSTRUCTION

REV. DATE AMENDMENT DRAWN CHECKED APPROVED SCALES PROPERTY DESCRIPTION PROJECT Central Coast PROPOSED SUBDIVISION "DRAFT LOT 5" OF LOT 2 IN D.P.1090329 & LOT 600 5 Pioneer Avenue, P.O. Box 3717, Tuggerah N.S.W. 2259 NOT TO SCALE IN D.P.1240613 & "DRAFT LOT 6" OF LOT 3 IN PLAN TITLE EROSION & SEDIMENT DETAILS CONTROL DETAILS & NOTES D.P.1090329 & LOT 728 IN D.P.1240614 Phone: (02) 4305 4300 Fax: (02) 4305 4399 RAYMOND TERRACE ROAD, CHISHOLM adw Property Group REV. ALL DIMENSIONS ARE IN METRES. DO NOT SCALE ONNS ARE IN METRES. DO NOT SCALE 50031(6N & 7N) - CENG - 611 DESIGN FILE S:\50031\50031(6)\Design\12D\STAGE 6 ENG DESIGN\STAGE_6_ENG_DESIGN.project

Plotted By: Michael Vella Plot Date: 20/01/21 11:03:49AM Cad File: S:\50031\50031(6N 7N)\DRAWINGS\ENGINEERING\CIVIL\CENG\50031(6N & 7N)-CENG-611.DWG