

#### **DRAWING REGISTER**

| DRAWING NUMBER     | SHEET NAME                             | REV. No. | REV. DATE |
|--------------------|--|----------|-----------|
| 13808.5 >> DA L001 | Site Plan                              | С        | 13/2/22   |
| 13808.5 >> DA L002 | Subdvision Street Tree Masterplan      | С        | 13/2/22   |
| 13808.5 >> DA L003 | Subdvision Street Tree Palette         | В        | 13/2/22   |
| 13808.5 >> DA L101 | Cessnock Road Treatment                | С        | 13/2/22   |
| 13808.5 >> DA L102 | MC01 - Arterial Road Treatment         | С        | 13/2/22   |
| 13808.5 >> DA L201 | Cessnock Road Entry Feature - option a | D        | 13/2/22   |
| 13808.5 >> DA L301 | Playground - Site Plan                 | С        | 13/2/22   |
| 13808.5 >> DA L302 | Playground - Detail Plan               | С        | 13/2/22   |
| 13808.5 >> DA L303 | Playground - Sections                  | С        | 13/2/22   |

## landscape development application

ReGrowth Kurri Kurri Landscape Design Loxford Project Management Pty Ltd

Cessnock Road, Gillieston Heights





Site Plan | L001

ReGrowth Kurri Kurri Landscape Design

ReGrowth Kurri Kurri Landscape Design

Cessnock Road, Gillieston Heights

**Loxford Project Management** Pty Ltd

JOB NUMBER: PHASE: DWG No: REV: **13808.5 DA L001 C** 



## Subdvision Street Tree Masterplan

#### ReGrowth Kurri Kurri Landscape Design

#### Tree species list

| Botanical Name                      | Common Name              | Н    | W    |
|-------------------------------------|--------------------------|------|------|
| DECIDUOUS TREES - collector i       | roads                    |      |      |
| Acer rubrum 'Redpointe'             | Red Maple                | 10 m | 4 m  |
| Nyssa sylvatca                      | Blackgum                 | 10 m | 4 m  |
| Pistacia chinensis                  | Chinese Pistacio         | 10 m | 8 m  |
| <b>EVERGREEN TREES - local road</b> | s, median strip & buffer |      |      |
| Alloxylon flammeum                  | Tree Waratah             | 12 m | 6 m  |
| Alphitonia excelsa                  | Red Ash                  | 8 m  | 6 m  |
| Backhousia myrtifolia               | Grey Myrtle              | 6 m  | 4 m  |
| Buckinghamia celsissima             | Ivory Curl Flower        | 6 m  | 3 m  |
| Caesalpinia ferrea                  | Leopard Tree             | 8 m  | 5 m  |
| Corymbia citriodora                 | Lemon Scented Gum        | 20 m | 10 m |
| Corymbia maculata 'Gamai'           | Spotted Gum              | 10 m | 4 m  |
| Elaeocarpus eumundii                | Smooth-leaved Quandong   | 8 m  | 4 m  |
| Eucalyptus robusta 'Matong'         | Swamp Mahogany           | 10 m | 6 m  |
| Eucalyptus sideroxylon 'Rosea'      | Ironbark                 | 12 m | 6 m  |
| Ficus rubiginosa                    | Port Jackson Fig         | 15 m | 15 m |
| Harpullia pendula                   | Tulipwood                | 6 m  | 6 m  |
| Lophostemon confertus               | Brushbox                 | 12 m | 6 m  |
| Stenocarpus sinuatus                | Firewheel Tree           | 8 m  | 3 m  |

# Legend SITE BOUNDARY STAGE BOUNDARY LOT BOUNDARY TURF MASS PLANTING FOOTPATH ACOUSTIC FENCE DETENTION AREA

DETENTION BASIN
DECIDUOUS TREE
EVERGREEN TREE

#### Notes

- 1 Northern drainage reserve with native planting and trees to comply with APZ requirements (by others).
- 2 Existing trees to park to be protected, managed and replaced through revegetation program.
- 3 Mixed clear trunked and shade trees to playground.
- 4 Double avenue of small shade trees to path network.
- 5 Mixed evergreen trees to local roads, to increase biodiversity and canopy cover. Refer Tree species list.
- 6 Buffer planting to Cessnock road. Refer L101 and Tree species list.
- 7 Large feature tree (Ficus sp.) to roundabout
- 8 Mixed everygreen native tree planting to median strip. Refer to Tree species list.
- 9 Feature deciduous trees to main collector roads, refer Tree species list.
- 10 Estate entry feature with mixed trees to establish biodiversity.
- 11 Estate entry feature with large iconic feature tree (Ficus sp,) and mixed trees to establish biodiversity.
- 12 Southern drainage reserve with native planting and trees to comply with APZ requirements (by others).
- 13 Existing trees to be retained and managed.

C 13/2/22 DA ISSU

PROJECT

ReGrowth Kurri Kurri Landscape Design

SITE:

Cessnock Road, Gillieston Heights

CLIEN

Loxford Project Management Pty Ltd

13808 S.REGROWTH.landscape view

DRAWN: AL / PW

DATE: 23.01.22

ER: PHASE: DWG No: I

JOB NUMBER: PHASE: DWG No: REV: 13808.5 DA L002 C





## Subdvision Street Tree Palette | L003

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deciduous trees - collector roads













evergreen trees - local roads













evergreen trees - local roads

Buckinghamia celsissima



Ironbark *Ficus rubiginosa* Port Jackson Fig Harpullia pendula





ReGrowth Kurri Kurri Landscape

Cessnock Road, Gillieston Heights

**Loxford Project Management** 

13808.5 DA L003 B



#### Cessnock Road Treatment | L101 ReGrowth Kurri Kurri Landscape Design | CESSOCK ROAD - SOUTHERN RESERVE (3a L201) CESSOCK ROAD - NORTHERN RESERVE CESSNOCK ROAD TREATMENT CESSOCK ROAD - NORTHERN RESERVE **CESSNOCK ROAD** CESSNOCK ROAD TREATMENT Notes Legend 1 Subdivision enty feature. SITE BOUNDARY 2 Northern drainage reserve STAGE BOUNDARY with native planting and trees to comply with APZ LOT BOUNDARY requirements. TURF 3 Curved sandstone acoustic wall to corners to contribute MASS PLANTING to placemaking. FOOTPATH 4 Vegetation buffer with acoustic fence - refer to detail ACOUSTIC FENCE DETENTION AREA 5 Existing trees to be retained. 6 Southern drainage reserve **DETENTION BASIN** with native planting and trees DECIDUOUS TREE to comply with APZ **EVERGREEN TREE CESSNOCK ROAD** requirements. 7 Indicative shared path link. NORTH BOUND TRAFFIC LANES ReGrowth Kurri Kurri Landscape Design SECTION AA TURF VERGE Cessnock Road, **Gillieston Heights** SHARED PATH **Loxford Project Management** Pty Ltd LOT BOUNDAR LAPPED & CAPPEL ACOUSTIC FENCE 13808.5 DA L101 C ,1500 1000, 2500 min 1700. CESSNOCK ROAD TREATMENT - detail plan

412 KING STREET NEWCASTLE NSW AUSTRALIA 2300

## MC01 - Arterial Road Treatment | L102

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#### Legend SITE BOUNDARY STAGE BOUNDARY LOT BOUNDARY TURF MASS PLANTING 5 Street trees as per Subdivision FOOTPATH Street Tree Masterplan - refer FEATURE WALL — ACOUSTIC FENCE

DECIDUOUS TREE

EVERGREEN TREE



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Cessnock Road,

Gillieston Heights

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MC01 - Arterial Road Treatment












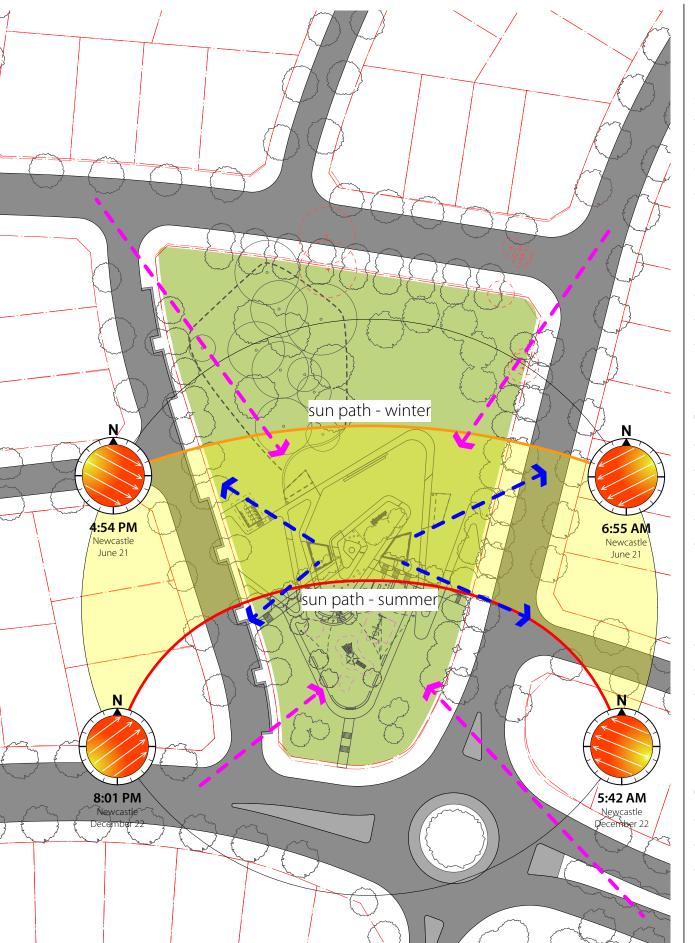

### KEY PRINCIPLES

#### Sun + shadow

- Reference to sunrise + sunset
- · Interactive sculptural + play elements
- Strong visual references
- Framed views in + out

#### ReGrowth

- · Create revegetation zone
- Plant new endemic species
- Manage existing trees

#### Connection

- · Views to broader landscape
- Accessible circulation paths
- Placemaking + wayfinding
- Strong visual landform + landmarks
- Social interaction

### **Engagment**

- Interactive play elements
- · Site specific placemaking
- Accessible + inviting
- Sculptural + music elements

#### Comfort

- · Shaded areas
- Cooling canopy cover
- Formal + informal seating + rest areas




ReGrowth Kurri Kurri SCALE: CLIENT: DATE: ISSUE:





## Cessnock Road Entry Feature - option a | L201


ReGrowth Kurri Kurri Landscape Design

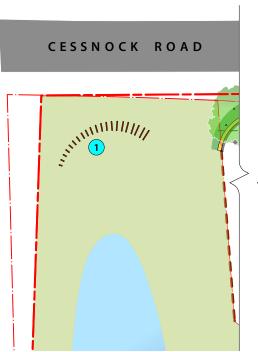






CESSNOCK ROAD - MAIN ENTRY

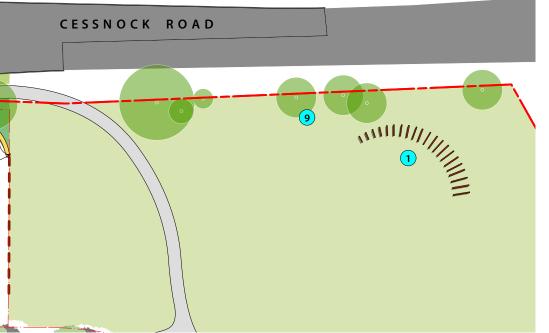

CESSNOCK ROAD - SOUTHERN RESERVE



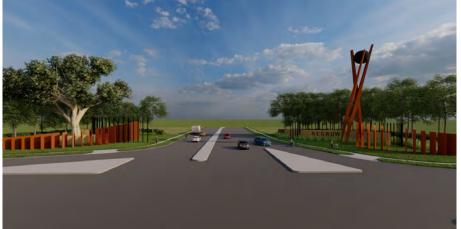







Notes

1 Drainage reserve with native planting, and feature element / artwork to match main entry

2 Shared path to connect with broader network.

3 Corten blades with uplighting. 4 Art element to provide

prominant landmark.

5 Sandstone wall with subdivision signage.

6 Native trees and grasses to provide biodiversity and green backdrop / screening to adjoining lots.

7 Large Fig as feature tree.

8 Vertical poles to form arc around entry feature and relate to vertical elements throughout the site.

9 Existing trees to be retained.

Cessnock Road,

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13808.5 DA L201 D



CESSNOCK ROAD ENTRY FEATURE - RENDERS

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## Playground - Site Plan L301 ReGrowth Kurri Kurri Landscape Design

- Picnic area to utilise existing shade trees, with serpentine sandstone wall to seperate revegetation area
- Circulation path with shade trees.
- Subdivision entry walls to intersection.
- be managed during replacement planting.
- path network.
- Shade trees to path network.

#### Notes

- Protected revegetation area. Existing trees to
- 5 Tall narrow trees to frame views in and out of
- 6 Kick around area with fence to roadside to contain balls (600m2). Connection to road crossing and broader
- 8 Accessible district playground refer to detail

#### SITE BOUNDARY STAGE BOUNDARY LOT BOUNDARY TURF MASS PLANTING MULCH DECKING BRICK PAVING CONCRETE RUBBER SANDSTONE LOG BUBBLER STEPS TABLE BBQ • FEATURE POSTS FALLZONE SHADE SAIL SCULPTURAL ELEMENT • DECIDUOUS TREE EVERGREEN TREE

Legend

ReGrowth Kurri Kurri Landscape Design

**Gillieston Heights** 

**Loxford Project Management** Pty Ltd

Cessnock Road,

JOB NUMBER: PHASE: DWG No: REV: **13808.5 DA L301 C** 





## Playground - Detail Plan | L302

#### ReGrowth Kurri Kurri Landscape Design

# +48.00 +46.00 +46.50 +44.00 AUBURN STREET HILLTOP DISTRICT PARK PLAYGROUND - DETAIL PLAN

#### Notes

- Protected revegetation area. Existing trees to be managed during replacement planting.
- 2 Picnic area to utilise existing shade trees, with serpentine sandstone wall to seperate revegetation area
- BBQ shelter.
- Bubbler.
- Accessible toilets.
- Accessible flying fox.
- Interactive sculptural element for informal
- Contrasting paths to assist with way-finding and mass planting aligned with sun paths.
- Viewing deck with seating, aligned to sunset.
- 10 Focal point at highest part of the park to feature interactive vertical elements including soft chimes, tall clear trunked trees, sculpture, and patterning to highlight sun path and shadow play.
- 11 Viewing deck with seating, aligned to sunrise.
- 12 Feature placemaking wall of recycled bricks.
- 13 Access stairs softened with mass planting.
- 14 Terraced sandstone walls with mass planting and natural play elements.
- 15 Bank of swings including inclusive basket
- 16 Terraced sandstone walls for informal play and seating.
- 17 Informal sitting walls for observation and balancing.
- 18 Shade sails to provide additional cover, designed to be strong visual element for views into the park.
- 19 Inclusive spinning and balancing equipment.
- 20 Playground with tall narrow tower, strong visual slide and clumbing challenges.
- 21 Circulation path with shade trees.
- 22 Tall narrow trees to frame views in and out of



SITE BOUNDARY

STAGE BOUNDARY

LOT BOUNDARY

TURF

MASS PLANTING

MULCH

DECKING

BRICK PAVING

CONCRETE

RUBBER

SANDSTONE LOG

• BUBBLER STEPS

TABLE

BBQ

• FEATURE POSTS

FALLZONE

SHADE SAIL

SCULPTURAL ELEMENT

DECIDUOUS TREE

EVERGREEN TREE

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Cessnock Road,

**Gillieston Heights** 

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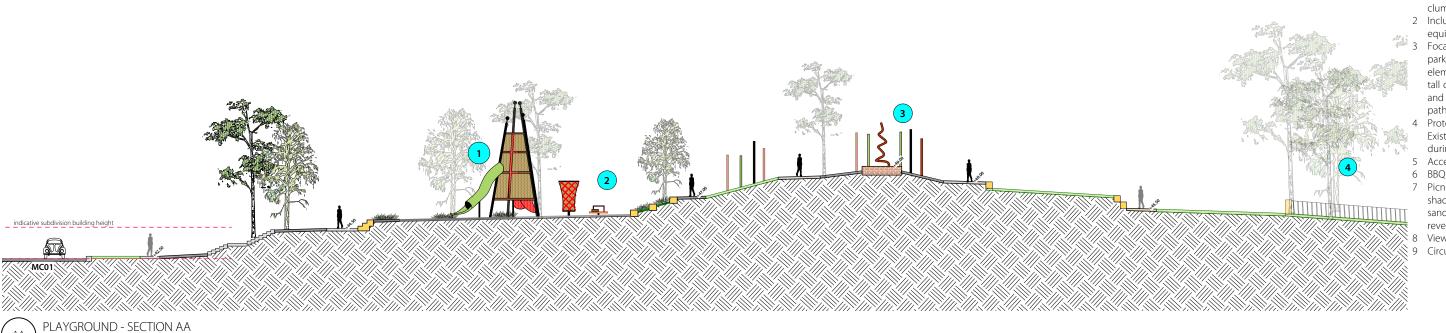
## Playground - Sections | L303


AUBURN STREET


ReGrowth Kurri Kurri Landscape Design

#### Notes

- 1 Playground with tall narrow tower, strong visual slide and clumbing challenges.
- 2 Inclusive spinning and balancing
- 3 Focal point at highest part of the park to feature interactive vertical elements including soft chimes, tall clear trunked trees, sculpture, and patterning to highlight sun path and shadow play.
  - Protected revegetation area. Existing trees to be managed during replacement planting.
  - Accessible toilets.
  - BBQ shelter.
  - Picnic area to utilise existing shade trees, with serpentine sandstone wall to seperate revegetation area
  - Viewing deck with seating.
  - 9 Circulation path with shade trees.



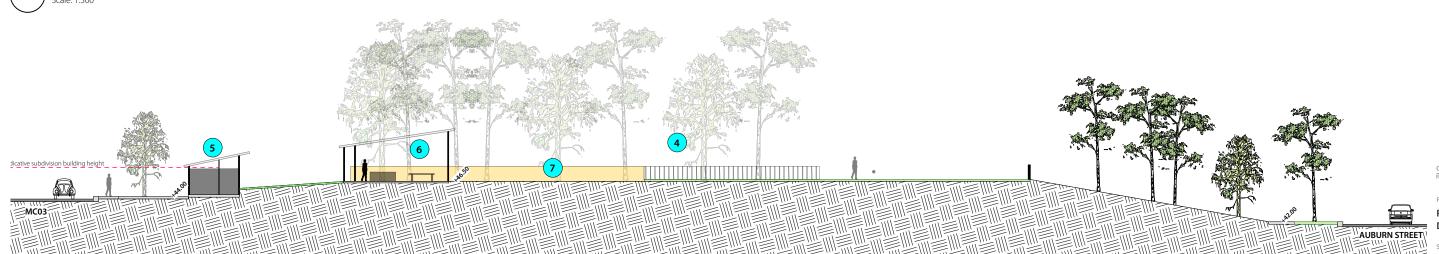

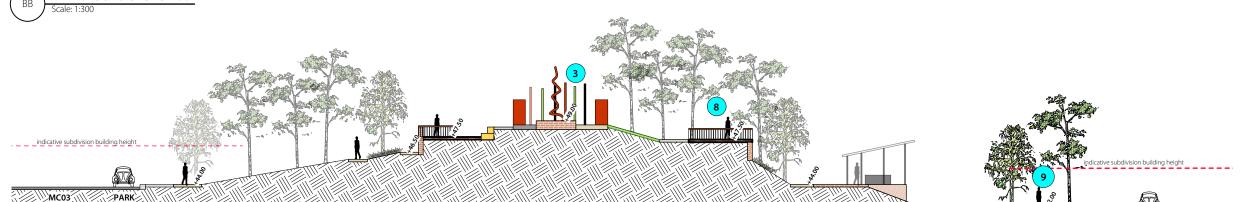

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PROJECT:

ReGrowth Kurri Kurri Landscape

Design

TE:

Cessnock Road, Gillieston Heights

CLIEN

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DRAWN: DATE:

DATE: SC >> START DATE

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CC PLAYGROUND - SECTION CC
Scale: 1:300