

AREAS - FLOOR					
*FLOOR AREA MEASURED FROM EXTERNAL FACE					
NAME AREA					
BUILDING AREA	959.7 m²				
TOTAL	959.7 m²				

AREAS - ROOF ARE	AS
NAME	AREA
ROOF AREA	1207.4 m²
TOTAL	1207.4 m²

AREAS - GROSS FLOOR AREA (GFA)				
MEASURE FROM INTERNAL FACE OF EXTERNAL WALL				
NAME AREA				
908.0 m ²				
908.0 m ²				

GENERAL PLAN SET NOTES: CHECK ALL DIMENSIONS ON SITE. THIS SECTION J NOTES: BUSHFIRE NOTES: SITE LEVEL NOTES: DRAWING IS TO BE READ IN CONJUNCTION WITH ALL RELEVANT CONTRACTS, SPECIFICATIONS, REPORTS, DRAWINGS, LEGENDS, NATIONAL CONSTRUCTION CODE, AUS & NZ STANDARDS, ENGINEERING & COUNCIL APPROVALS



	Note: Cop All rights reproduce electronic otherwise
collinswcollins	copyright DO NOT S check all t
Building Designers	commenc

Copyright © 2021: Collins.w.Collins PTY LTD ts reserved. No part of this drawing may be uced or transmitted in any form or by means, nic, mechanical, photocopying, recording or rise, without the prior permission of the

th holders.

T SCALE from this drawing. CONTRACTOR is to check all the dimensions on the job prior to commencement of shop drawings or fabrication. Discrepancies to be referred to the consultant Designer prior to commencement of work.

PROJECT: PROPOSED CHILD CARE CENTRE			SITE PL	AN	DRAWING REVISIONS + NOTES			
					Date:	Description:		
STATUS: CONSTRUCTION	CLIEFT.	1 OE 12	SCALE:	1:200	08.12.21	INITIAL ISSUE		
PARENT LOT/DP NO: 520/1276572	SHEET:	SHEET: 1 OF 13	SHEET SIZE:	A2				
STREET: LOT 611 SUNSET DR, THORNTON, NSW, 2322		STILLT SIZL.	AZ					
-	,		START DATE:	01.11.21				
CLIENT: LANDLINK PROJECTS GROUP PTY LTD			DWG No:	D5038				


08.12.21 INITIAL ISSUE

PRELIMINARY ONLY EXTERNAL FINISHES LABEL MATERIAL DESCRIPTION BLOCKWORK DRR(L) CORRUGATED METAL SHEET ROOFING (LIGHT) SCYON LINEA 180MM WIDE CLADDING SCYON MATRIX 2390MM X 600MM CLADDING CORRUGATED METAL SHEET ROOFING (LGT) COLOUR: LIGHT (SA - <0.475) WITH R1.3 (REFLECTIVE SIDE DOWN, ANTI-GLARE UP) CORRUGATED METAL SHEET ROOFING (LGT) COLOUR: LIGHT (SA - <0.475) WITH R1.3 (REFLECTIVE SIDE DOWN, ANTI-GLARE UP) 140MM X 140MM TIMBER POSTS SOLAR PANELS (CLIP SNAP) CONTINUOUS OVERFLOW GUTTER FIXING SYSTEM TO COMPLY WITH AS 3500.3 OVERFLOW GUTTER FIXING SYSTEM TO COMPLY WITH AS 3500.3 CORR(L) 7.00° 900 COLUMNS TO ENGINEER'S DETAIL. ALL SELECTED CLADDING TO COMPLY WITH BCA REGULATIONS & REQUIREMENTS 1. NORTH ELEVATION 1:100 (CLIP SNAP) CONTINUOUS OVERFLOW GUTTER FIXING SYSTEM TO COMPLY WITH AS 3500.3 140MM X 140MM TIMBER POSTS SOLAR PANELS 140MM X 140MM TIMBER POSTS 300 (MAT 7.00° CORR(L) 00 L 7.00° == TIMBER SLAT GATE -COLUMNS TO ENGINEER'S DETAIL. ALL SELECTED CLADDING WHEEL STOP 1.2M HIGH SELF-LOCKING 5. BIN AREA ELEVATION (FRONT) 6. BIN AREA ELEVATION (SIDE) TO COMPLY WITH BCA REGULATIONS & REQUIREMENTS SAFETY GATE & BARRIER 2. EAST ELEVATION 1:100 1:100 1:100



3. SOUTH ELEVATION

1:100

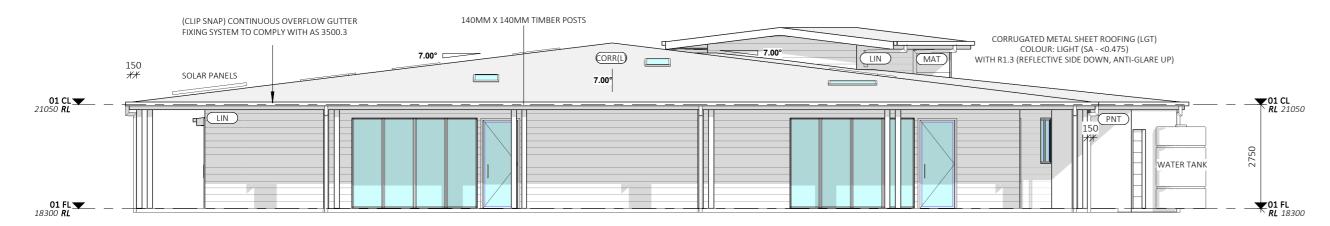

4. WEST ELEVATION

1:100


REPORTS, DRAWINGS, LEGENDS, NATIONAL CONSTRUCTION CODE, AUS	DRAWING IS TO BE READ IN CONJUNCTION WITH ALL RELEVANT CONTRACTS, SPECIFICATIONS, REPORTS, DRAWINGS, LEGENDS, NATIONAL CONSTRUCTION CODE, AUS & NZ STANDARDS, ENGINEERING &	SECTION J NOTES:	BUSHFIRE NOTES:	SITE LEVEL NOTES:
---	---	------------------	-----------------	-------------------

Note: Copyright © 2021: Collins.w.Collins PTY LTD All rights reserved. No part of this drawing may be	PROJECT: PROPOSED CHILD CARE CENTRE		ELEVATIONS		DRAWING REVISIONS + NOTES																							
reproduced or transmitted in any form or by means,		THE SELD STILLS OF THE SELVING			Date:	Description:	Issue:	Drawn:																				
COLINSWCOLINS Building Designers otherwise, without the prior permission of the copyright holders. DO NOT SCALE from this drawing. CONTRACTOR is to check all the dimensions on the job prior to commencement of shop drawings or fabrication. Discrepancies to be referred to the consultant	STATUS: CONSTRUCTION	CULET: 1 OE	SHEET: 4 OF 13	SCALE:	1:100	08.12.21	INITIAL ISSUE	Α	ВІ																			
	copyright holders.	PARENT LOT/DP NO: 520/12/65/2	3HEE1. 4 OI 13	SHEET SIZE:	A2																							
		STREET: LOT 611 SUNSET DR, THORNTON, NSW, 2322		STILLT SIZL.	LLI 3IZL. AZ			_																				
			START DATE:	01.11.21																								
		CLIENT: LANDLINK PROJECTS GROUP PTY L	TD		DWG No:	D5038																						
89A lord street (PO Box 5667), Port Macq	uarie NSW 2444 Shop 17 Centrepoint	Arcade, Taree NSW 2430 T:	02 6583 441	.1	F: 02	6583 9820		WWW. COLLINSWCOL	LINS.C	OM.AU																		



Plant List

ID	Botanical Name	Common Name	Pot Size	Mature Height	Mature Spread	Qty
Trees						
AS	Acmena smithii	Lilly Pilly	45L	10 - 15m	3.5 - 6m	2
ВМу	Backhousea myrtifolia	Grey Myrtle	45L	7m	3 - 4m	2
CA	Cupaniopsis anacardioides	Tuckeroo	75L	10 - 15m	3.5 - 6m	5
ER	Elaeocarpus reticulatus	Blueberry Ash	45L	5 - 10m	3.5 - 6m	6
GF	Glochidion Ferdinandi	Cheese Tree	45L	8m	5m	6
WF	Waterhousia floribunda	Weeping Lilly Pilly	45L	5 - 10m	3.5 - 6m	5
Shrubs						
ACS	Acmena 'Cherry Surprise'	Cherry Surprise	200mm	3m	1m	51
ASM	Acmena smithii 'Minor'	Lilly Pilly	200mm	2- 3m	1- 2m	77
BVN	Baeckea virgata nana	Dwarf Baeckea	200mm	1m	1m	9
CLJ	Callistemon 'Little John'	Little John	200mm	1m	1m	14
НМН	Hardenbergia `Mini-Ha-Ha`	Mini-Ha-Ha	140mm	0.3 - 0.45m	1.5m	18
IA	Indigophora australis	Austral Indigo	140mm	2m	1m	6
SYC	Syzygium 'Cascade'	Cascade	200mm	2 - 3m	2m	45
SzR	Syzygium 'Resilience'	Resilience	200mm	3m	1m	9
Ground	Covers					
DC	Dianella caerulea	Paroo Lily, Blue Flax-lily	140mm	0.45 - 0.6m	0.3 - 0.6m	18
Grasses						
LLT	Lomandra 'Lime Tuff'	Lomandra 'Lime Tuff'	140mm	0.5m	0.5m	15
LL	Lomandra longifolia	Spiny-headed Mat-Rush	tube	0.75 - 0.9m	0.9 - 1.2m	19
Climbers	3					
HSc	Hibbertia scandens	Guniea Flower	140mm	0.3 - 0.45m	4 - 6m	10

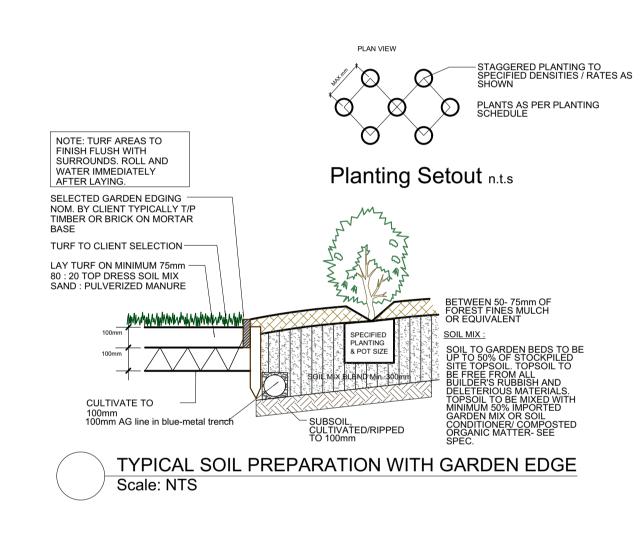

LANDSCAPE WORK SPECIFICATION

PRELIMINARIES 1.01 GENERAL

The following general conditions should be considered prior to the commencement of landscape works: The landscape plans should be read in conjunction with the architectural plans, hydraulic plans, service plans and survey prepared for the proposed development. · All services including existing drainage should be accurately located prior to the commencement of landscape installation. Any proposed tree planting which falls close to services will be relocated on site under the instruction of the landscape architect.

Installation of conduit for required irrigation, electrical and other services shall be completed prior to the commencement of hardscape works and hardstand pours. All outdoor lighting specified by architect or client to be installed by qualified electrician Anomalies that occur in these plans should be brought to our immediate attention. Where an Australian Standard applies for any landscape material testing or installation technique, that standard shall be followed.

1.02 PROTECTION OF ADJACENT FINISHES

1.03 PROTECTION OF EXISTING TREES

The Contractor shall take all precautions to prevent damage to all or any adjacent finishes Specified Soil Mix - Turf by providing adequate protection to these areas / surfaces prior to the commencement of The specified soil mix for all turf areas shall be a min 75mm layer of imported soil mix

Existing trees identified to be retained shall be done so in accordance with AS 4970-2009. Site Topsoil

Where general works are occurring around such trees, or pruning is required, a qualified Arborist shall be engaged to oversee such works and manage tree health. Existing trees designated on the drawing for retention shall be protected at all times during toxic to plants. The topsoil must have a pH of between 5.5 and 7. the construction period. Any soil within the drip-line of existing trees shall be excavated and removed by hand only. No stockpiling shall occur within the root zone of existing trees 2.02 INSTALLATION to be retained.

Any roots larger in diameter than 50mm shall only be severed under instruction by a qualified arborist. Roots smaller than 50mm diameter shall be cut cleanly with a saw.

prior to the commencement of landscape works. The location of this fencing will be as per ensure conditions are appropriate for planting as stated above. the TPZ defined by the consulting Arborist. If no Arborists report is available, install fence around the drip line of these trees, or a minimum of 3m from the trunk. The fencing shall be Note that a soil test conducted by "SESL Australia" or approved equal shall be prepared for Plant true to type, Good vigour and health, free from pest & disease, free from injury. maintained for the full construction period.

1.04 EROSION & POLLUTION CONTROL

The Contractor shall take all proper precautions to prevent the erosion of soil from the by council, and maintain these barriers throughout the construction period. Note that the services. sediment control measures adopted should reflect the soil type and erosion characteristics

Erosion & pollution control measures shall incorporate the following:

- Construction of a sediment trap at the vehicle access point to the subject site. - Sediment fencing using a geotextile filter fabric in the location indicated on the erosion control plan or as instructed on site by the landscape architect. - Earth banks to prevent scour of stockpiles

Sandbag kerb sediment traps - Straw bale & geotextile sediment filter.

- Exposed banks shall be pegged with an approved Jute matting in preparation for mass

Refer to "Sitewise Reference Kit" as prepared by DLWC & WSROC (1997) for construction Cultivate all subgrades to a minimum depth of 150mm in all planting beds and all turf

SOIL WORKS 2.01 MATERIALS

Specified Soil Conditioner - Mass planting in natural ground The specified soil conditioner for mass planting shall be an organic mix, equal to "Soil conditioner", as supplied by Oz Landscaping Supplies. Note that for sites where soil testing indicates toxins or extremes in pH. or soils that are extremely poor, allow to excavate and supply 300mm of imported soil mix.

consisting of 80% washed river sand (reasonably coarse), and 20% composted organic matter equivalent to mushroom compost or soil conditioner, or other approved lawn top

Site topsoil is to be clean and free of unwanted matter such as gravel, clay lumps, grass, weeds, tree roots, sticks, rubbish and plastics, and any deleterious materials and materials soil levels, in preparation for planting and turfing.

All testing is to be conducted in accordance with AS 4419-2003 Soils for landscaping and garden use for an in depth soil analysis for pre-planting and diagnostic assessment of the 1.8m high temporary fencing shall be installed around the base of all trees to be retained Tests shall be taken in several areas where planting is proposed, and site soil modified to

> all commercial, industrial and multi-unit residential sites. The successful landscape contractor shall implement the recommendations of this test.

b) Set Out of Individual Trees & Mass Planting Areas

All individual tree planting positions and areas designated for mass planting shall be set subject site. The contractor shall install erosion & sediment control barriers and as required out with stakes or another form of marking, ready for inspection and approval. Locate all

c) Establishing Subgrade Levels

Subgrade levels are defined as the finished base levels prior to the placement of the specified material (i.e. soil conditioner). The following subgrade levels shall apply: Mass Planting Beds - 300mm below existing levels with specified imported soil mix. - Turf areas - 100mm below finished surface level. Note that all subgrades shall consist of a relatively free draining natural material, consisting c) Mulch

d) Subgrade Cultivation

areas, ensuring a thorough breakup of the subgrade into a reasonably coarse tilth. Grade subgrades to provide falls to surface and subsurface drains, prior to the placement of the final specified soil mix.

Install surface and subsurface drainage where required and as detailed on the drawing. Drain subsurface drains to outlets provided, with a minimum fall of 1:100 to outlets and / or

f) Placement and Preparation of Specified Soil Conditioner & Mixes. - Trees in turf & beds - Holes shall be twice as wide as root ball and minimum 100mm

deeper - backfill hole with 50/50 mix of clean site soil and imported "Organic Garden Mix" as supplied by Oz Landscape Supplies or approved equal. - Mass Planting Beds - Install specified soil conditioner to a compacted depth of 100mm Place the specified soil conditioner to the required compacted depth and use a rotary hoe to thoroughly mix the conditioner into the top 300mm of garden bed soil. Ensure thorough mixing and the preparation of a reasonably fine tilth and good growing medium in

Turf Areas - Install specified soil mix to a minimum compacted depth of 75mm Place the specified soil mix to the required compacted depth and grade to required finished c) Staking and Tying

3.01 MATERIALS

Ross Clark's book.

a) Quality and Size of Plant Material

In General, the principles & standards outlined in "Specifying Trees - a guide to assessment of tree quality" by Ross Clark will be demanded in the quality of all planting stock specified. These principles include, but are not limited to: Above - Ground Assessment: The following plant quality assessment criteria should be followed:

self-supporting, good stem taper, has been pruned correctly, is apically dominant, has even crown symmetry, free from included bark & stem junctions, even trunk position in pot, good stem structure Below - Ground Assessment: Good root division & direction, rootball occupancy, rootball depth, height of crown, non-suckering For further explanation and description of these assessment criteria, refer to

All Plant material shall be to the type and size specified. No substitutions of plant material shall be permitted without written prior approval by the Landscape Architect. No plant shall adjacent surfaces. be accepted which does not conform to the standards listed above.

Fertilizers shall be approved slow release fertilisers suitable for the proposed planting types. Note that for native plants, specifically Proteaceae family plants including Grevillea species, low phosphorus fertilizers shall be used.

of site topsoil placed previously by the Civil Contractor. No builders waste material shall be Mulch shall be leaf litter mulch equal to "Forest Blend" as supplied by ANL. Mulch shall be completely free from any soil, weeds, rubbish or other debris.

Turf shall be "Kakadu" Buffalo or equivalent (unless stated otherwise), free from any weeds

3.02 INSTALLATION

and other grasses, and be in a healthy growing condition.

a) Setting Out All planting set out shall be in strict accordance with the drawings, or as directed. Note that surface requirements, while providing a useable, hardwearing, practical surface. proposed tree planting located near services should be adjusted at this stage. Notify Landscape Architect for inspection for approval prior to planting

All plant material shall be planted as soon after delivery as possible. Planting holes for trees shall be excavated as detailed and specified. Plant containers shall be removed and discarded, and the outer roots gently teased from the soil mass. Immediately set plant in hole and backfill with specified soil mix, incorporating the approved quantity of fertiliser for each plant type. Ensure that plants are set plumb vertically and root balls set to the consolidated finished grades detailed on the drawings. Compact the backfilled soil and

Trees shall be of a quality that, when planted, are freestanding, without the aid of stakes or

saturate by hand watering to expel any remaining air pockets immediately after planting.

Mulch should be spread so that a compacted thickness of 75mm is achieved after settlement in all planting beds and around each individual plant. Apply immediately following planting and watering in, ensuring that a 50mm radius is maintained around the trunk of each plant. In all planter boxes, mulch to finish between 25-50mm below top of planter. There shall be no mixing of soil and mulch material.

Moisten soil prior to the turf being laid. Turf shall be neatly butt jointed and true to grade to finish flush with adjacent surfaces. Incorporate a lawn fertilizer and thoroughly water in. Keep turf moist until roots have taken and sods/rolls cannot be lifted. Keep all traffic off turf done so as to ensure that the working pressure at the end of the line does not decrease by until this has occurred. Allow for top dressing of all turf areas. All turf shall be rolled

immediately following installation

ties, else they will be rejected.

The Contractor shall install garden edging to all mass planting beds adjoining turf or gravel mulched areas, and where required. The resultant edge shall be true to line and flush with Garden Edging: to be Treated Pine Timber edging (Unless otherwise specified by

Ensure root barrier is installed to all edges/junctions beween the garden bed and adjacent hard surfaces including but not limited to retaining walls, carparking, paths, underground

pipes and tanks and buildings within a 3m radius of the trunk of any proposed trees. Equivalent to treemax root barrier. Install root barrier to manufacturer's instructions. HARDSCAPE WORKS

4.01 GENERAL

The Contractor shall undertake the installation of all hardscape works as detailed on the drawing, or where not detailed, by manufacturers specification.

Refer to typical details provided, and applicable Australian Standards. Permeable paving may be used as a suitable means of satisfying Council permeable In most instances, the client shall nominate the appropriate paving material to be used.

Australian Standards shall be adhered to in relation to all concrete, masonry & metal work. Some details are typical and may vary on site. All hardscape works shall be setout as per the drawings, and inspected and approved by the Landscape Architect prior to installation. All workmanship shall be carried out in a tradesman-like manner. Any queries or problems that arise from hardscape variations should be bought to the attention of the Landscape

IRRIGATION WORKS

5.01 GENERAL (PERFORMANCESPECIFICATION)

New irrigation systems to planting areas shall be a Commercial Grade Irrigation System conforming to AS 3500 & the latest Sydney Water Code

The irrigation system shall be installed prior to all planting works. It shall incorporate a commercially available irrigation system, with dripper lines for all trees, and suitable jet sprinkler heads for the shrub species specified. It shall also incorporate a suitable back flow prevention device for the scale of works, an in-line filter, check valves, and suitable high and low density poly hose fittings and PVC piping to achieve flow rates suitable for

The landscape contractor shall check the existing pressure available from the ring mains and size irrigation piping to suit. Supply shall be from local hose cock where available. All piping and fittings are to be buried 50mm below the finished soil levels in garden bed areas, and secured in position at 5m centre with galv wire pins. Sizing of pipes shall be

more than 5%. Upon completion of installation, the system shall be tested and all components are to be satisfactorily functional and operational prior to approval. Should any defect develop, or the capacity or efficiency of the system decline during the agreed maintenance system, then

Detailed drawings of the entire proposed irrigation system shall be made available to the client for records and future maintenance of the system.

CONSOLIDATION AND MAINTENANCE

The consolidation and maintenance period shall be 12 months beginning from the approved completion of the specified construction work (Practical Completion) except in the case of street trees, which shall be maintained for a period of 24 months. A qualified landscape maintenance contractor shall undertake the required landscape maintenance works. Consolidation and maintenance shall mean the care and maintenance of Contracted works by accepted landscaping or horticultural practices, ensuring that all plants are in optimum growing conditions and appearance at all times, as well as rectifying any defects that become apparent in the contracted works.

This shall include, but not be limited to, the following items where and as required:

Watering all planting and lawn areas / irrigation maintenance. - Clearing litter and other debris from landscaped areas. Removing weeds, pruning and general plant maintenance. Replacement of damaged, stolen or unhealthy plants. Make good areas of soil subsidence or erosion. - Topping up of mulched areas.

 Spray / treatment for Insect and disease control. - Fertilizing with approved fertilizers at correct rates. - Mowing lawns & trimming edges each 14 days in summer or 18 days in winter

- Maintenance of all paving, retaining and hardscape elements. On the completion of the maintenance period, the landscape works shall be inspected and at the satisfaction of the superintendent or landscape architect, the responsibility will be signed over to the client.

SCALE 1:200 Amendments:

B MINOR AMENDMENTS

C MINOR AMENDMENTS

No: Amendments:

MERAKI GREEN LANDSCAPE ARCHITECTURE A: 33 Ulolo Avenue, Hornsby Heights NSW 2077 | M: 0404 444 045

29.04.21

26.08.21

Date:

A.B.N. 44 775 747 742

E: enquiries@merakigreenlandscapearchitecture.com.au

LANDSCAPE PLAN

TITLE:

PROPOSED CHILDCARE CENTRE LOT 722, 723 & 724 DP10419 **THORNTON**

Client: Landlink Property

SCALE: 1:200@ A1 DATE: 26 APRIL 2021

PROJECT NO.: 2133 DWG NO.: LP.O1 / C ISSUE: C