


04. 04/03/2022 DEVELOPMENT APPLICATION - ISSUE A 05. 25/03/2022 DEVELOPMENT APPLICATION - ISSUE B

NOM. ARCHITECT LAURAN TREVENA 10054

EVIEW)	LOT 602 & 603 KESTREL AVE. THORNTON, NSW		20.21.10	00	1.200, 1.140.70 @ 7
ł	PROJECT	DRAWING STATUS	LAYOUT NO.	REVISED BY	PRINT DATE
}	PROPOSED INDUSTRIAL COMPLEX	DEVELOPMENT APPLICATION - ISSUE B	A / DA11	LT	25/03/2022

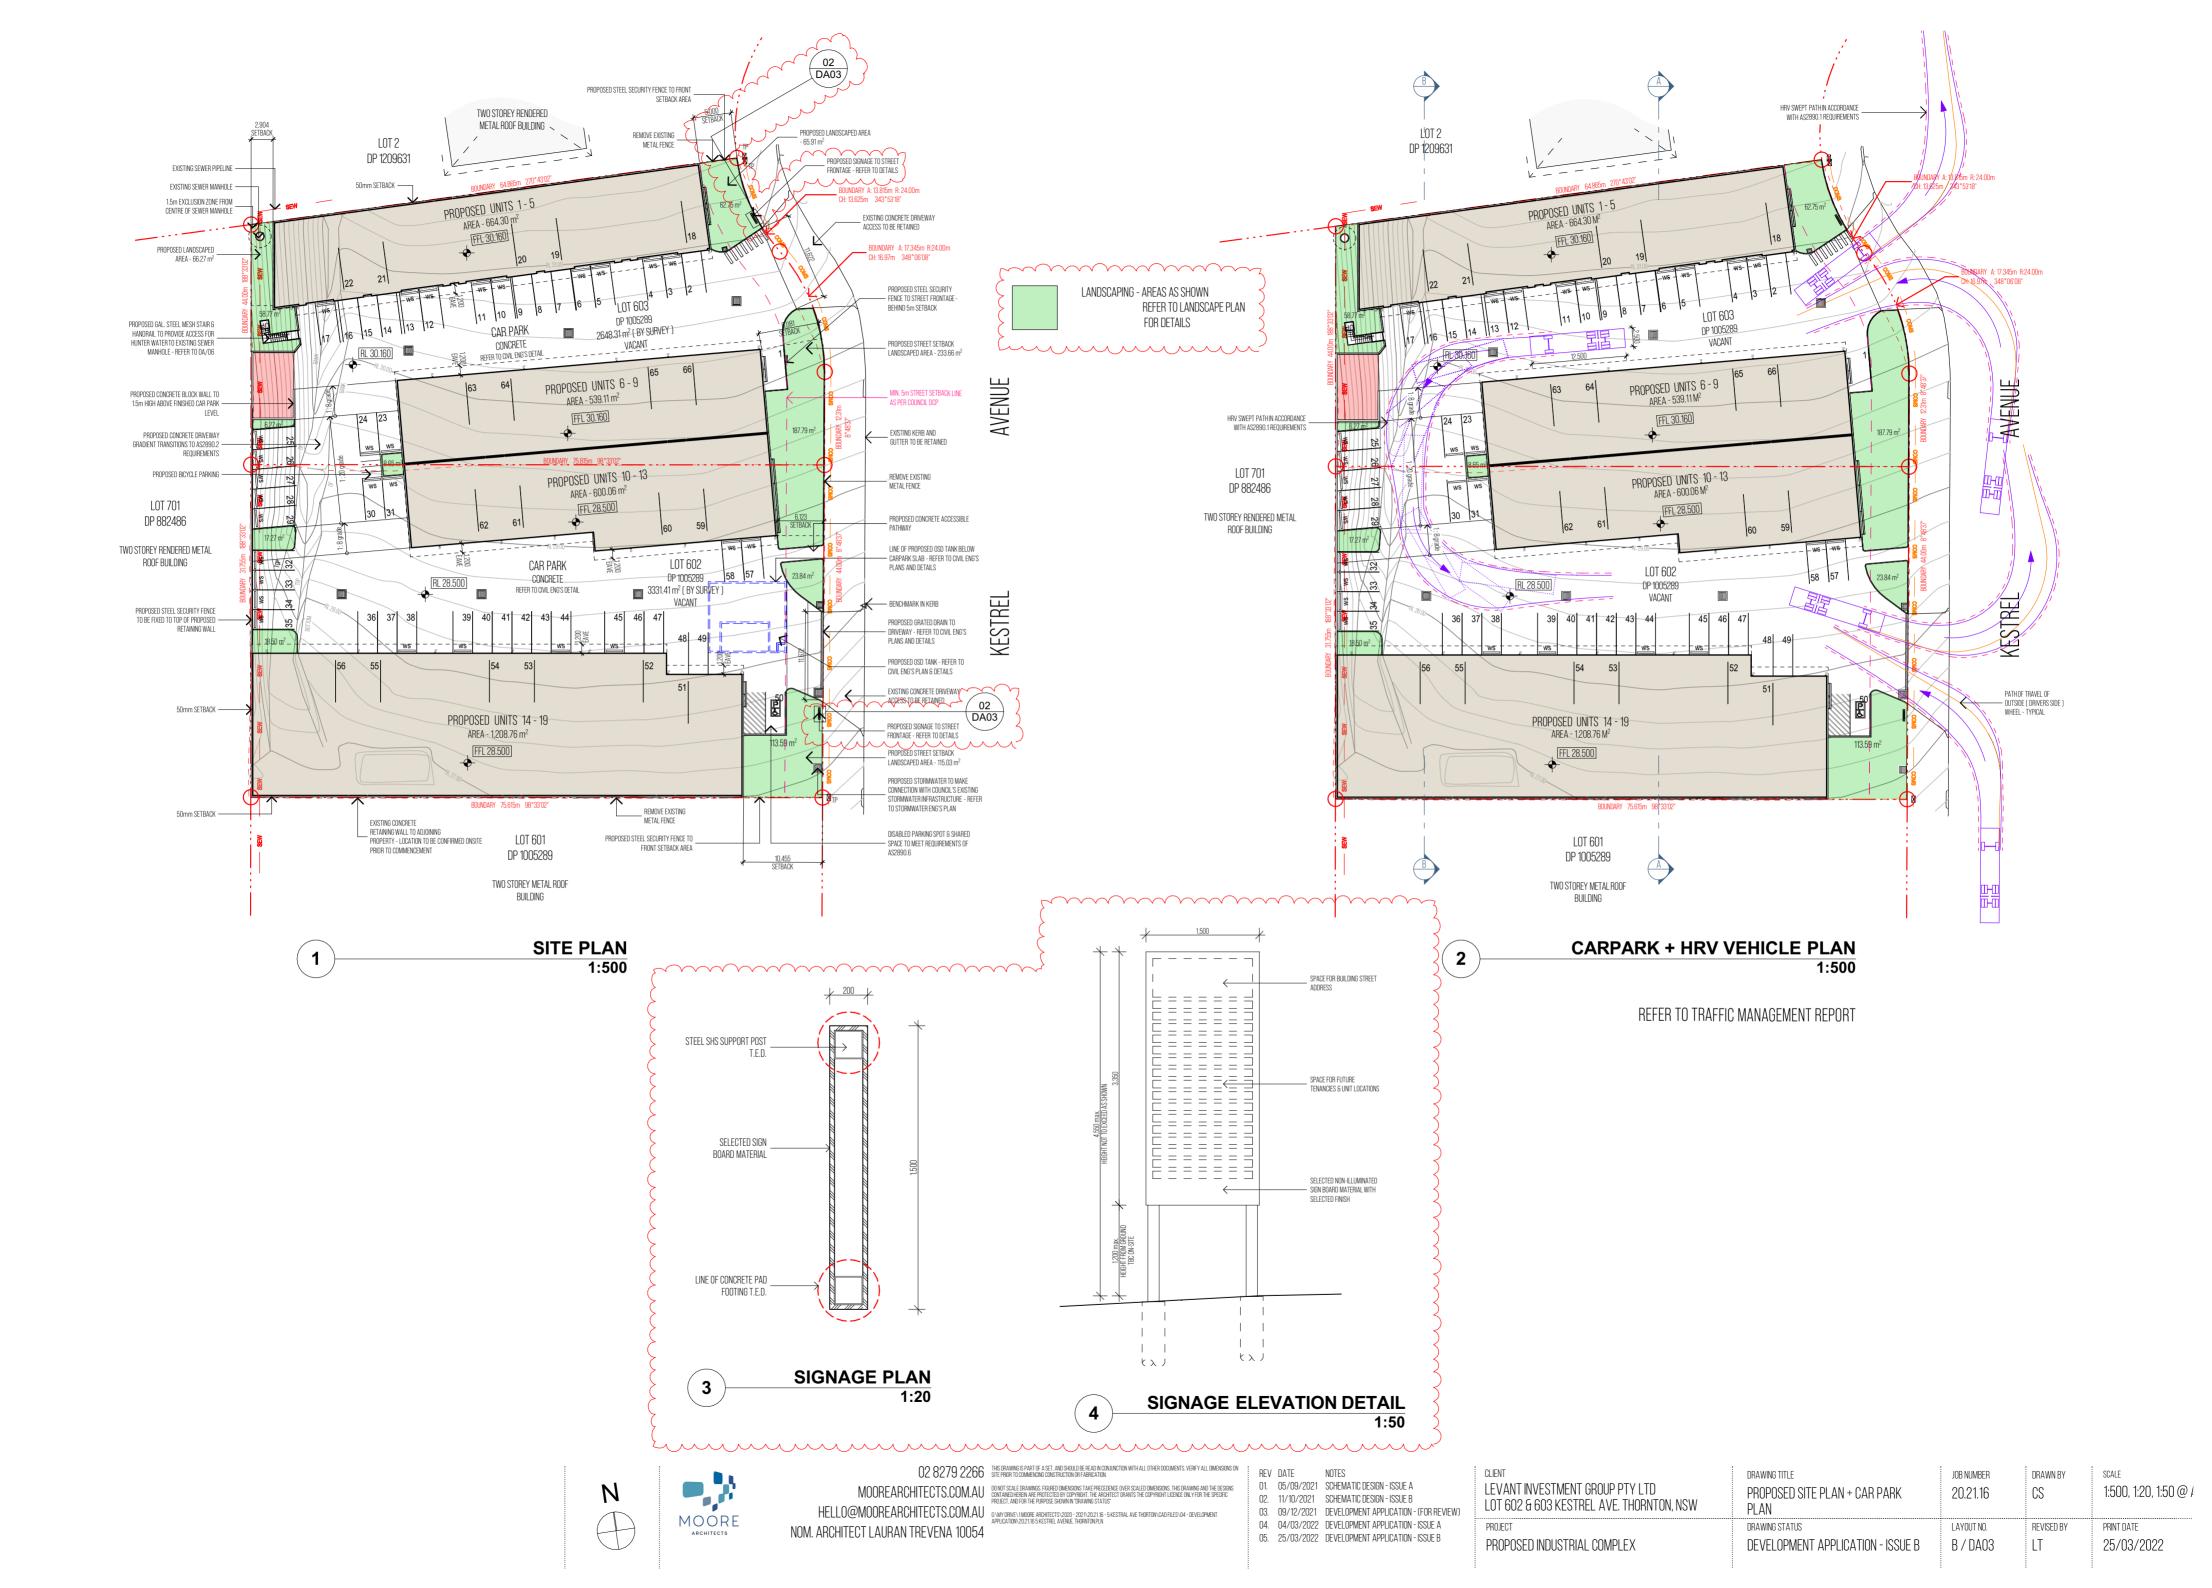















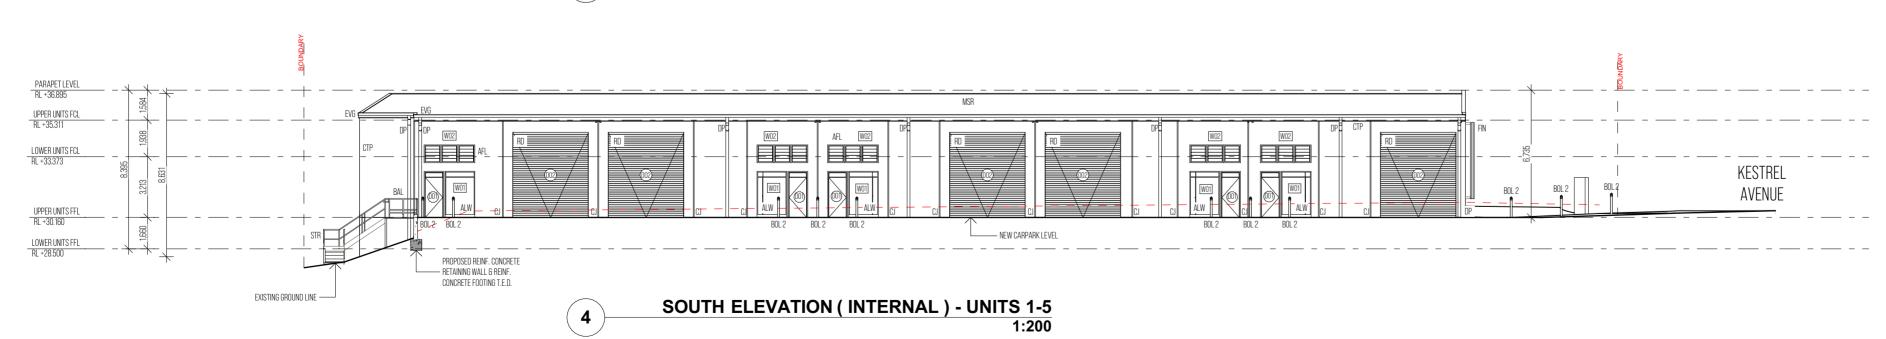



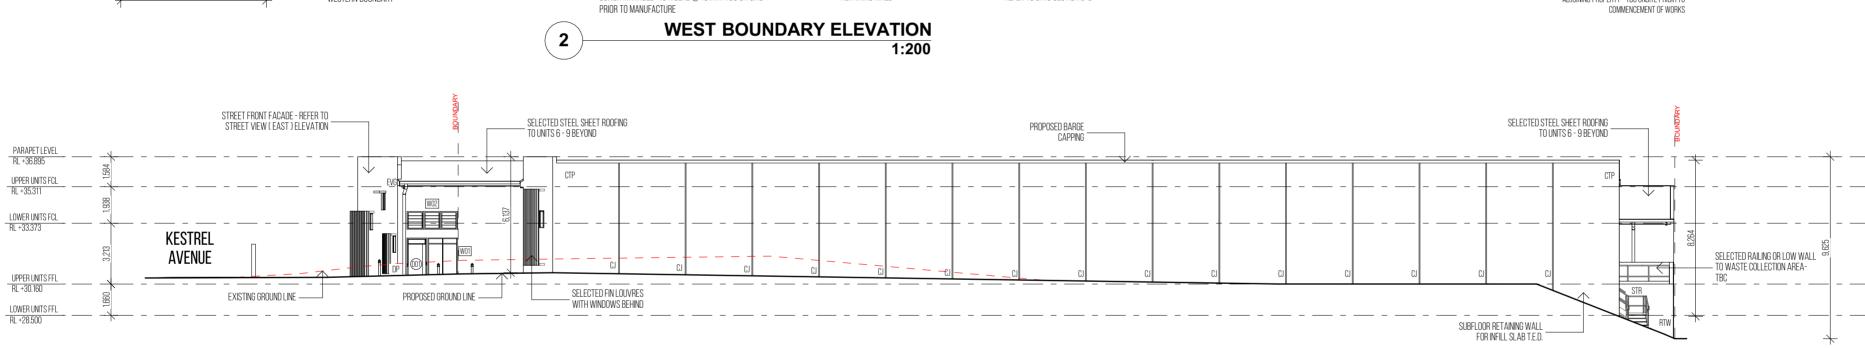

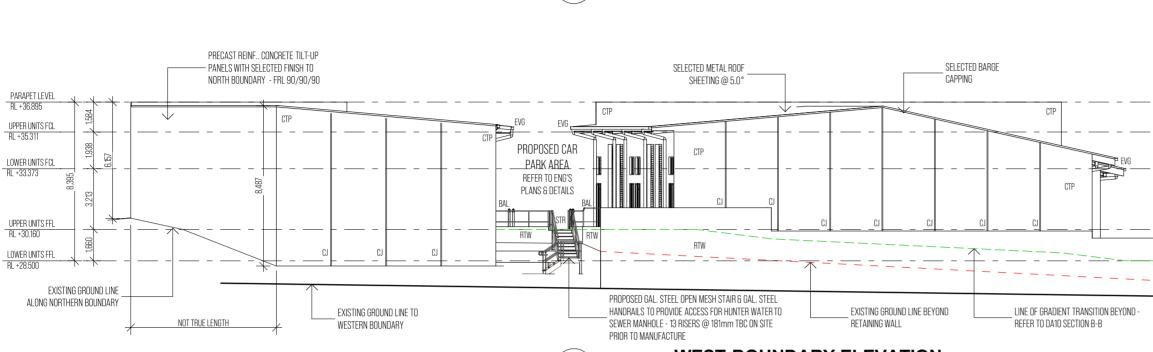

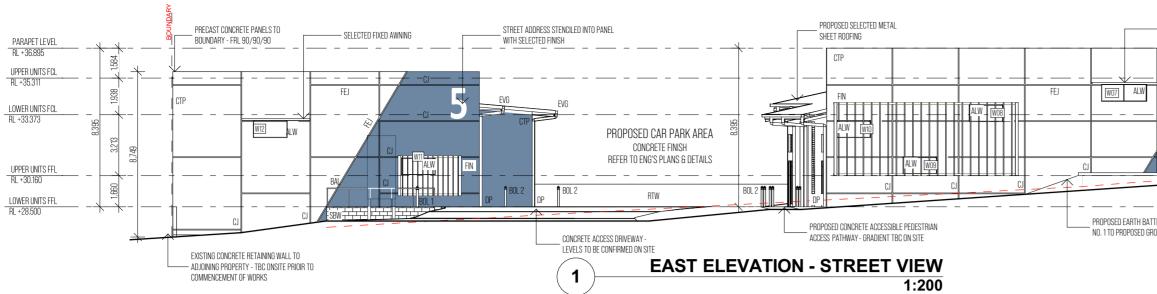

	PROPOSED SELECTED ALUMINIUM FRAMED LOUVRE WINDOWS OVER ENTRY	PROPOSED SELECTED STEEL ROLLER DOOR	PRECAST CONCRETE PANELS T BOUNDARY - FRL 90/90/9	
			FN	
ATTER FROM CARPARK GROUND LEVEL	CONCRETE ACCESS DRIVEWAY LEVELS TO BE CONFIRMED ON SITE	PR	OPOSED GROUND LINE EXISTING C	SROUND LINE
	TOP OF PROPOSED PARAPET 	FRL 90/90/90	CTP	
PROPOSED CAR PARK AREA REFER TO ENG'S PLANS & DETAILS				
LINE OF CAR F		EX	ISTING CONCRETE RETAINING WALL TO NG PROPERTY - TBC ONSITE PRIDIR TO COMMENCEMENT OF WORKS	7

NTS. VERFY ALL DIMENSIONS ON IS DRAWING AND THE DESIGNS DE ONLY FOR THE SPECIFIC SOLA - DEVELOPMENT	02. 11/10/2021	NOTES Schematic Design - Issue A Schematic Design - Issue B Development Application - (For Review)	^{CLIENT} LEVANT INVESTMENT GROUP PTY LTD LOT 602 & 603 KESTREL AVE. THORNTON, NSW	DRAWING TITLE ELEVATIONS	JOB NUMBER 20.21.16	DRAWN BY CS	^{scale} 1:200 @ A2
NUH - LIE VELUTIKEN	04. 04/03/2022	DEVELOPMENT APPLICATION - ISSUE A DEVELOPMENT APPLICATION - ISSUE B	PROJECT PROPOSED INDUSTRIAL COMPLEX	DRAWING STATUS DEVELOPMENT APPLICATION - ISSUE B	layout no. A / DAO8	REVISED BY LT	PRINT DATE 25/03/2022

LEGEND

TYP.

- ALUMINIUM FRAMED WINDOW
- ALUMINIUM FRAMED LOUVRE WINDOW
- SELECTED EXTERNAL BALUTRADE TO MEET
REQUIREMENTS OF BCA PART 3.9.1
- SELECTED BOLLARD TO DISABLED CAR PARK SHARED
SPACE TO MEET REQUIREMENTS OF AS2890.6 &
AS1428.1
- SELECTED BOLLARD TO PREVENT VEHICLE BLOCKAGE
OF DOORWAY CIRCULATION SPACE AND TO MAINTAIN
EMERGENCY EGRESS
- Control Joint
- PRECAST CONCRETE TILT-UP PANEL T.E.D.
- SELECTED 150mm Ø DOWNPIPE TO AS/NZS2179.1
& AS/NZS3500.3
- ENGINEER'S
- SELECTED COLRBOND GUTTER TO AS/NZS2179.1
& AS/NZS3500.3
- FALSE EXPRESSED JOINT - TYPICALLY HORIZONTAL
JOINTS UNLESS SHOWN OTHERWISE
- FINISHED FLOOR LEVEL
- SELECTED FIXED LOUVRE FIXED TO STEEL
STRUCTURAL SUPPRT T.E.D.
- FIRE RESISTENCE LEVEL
- GALVANISED
- SELECTED 150mm HIGH CONCRETE KERB
- SELECTED CORRUGATED METAL SHEET ROOFING
- SELECTED STEEL ROLLER
- REINFORCED
- RETAINING WALL T.E.D.
- SELECTED SPLIT-FACED CONCRETE BLOCKWORK
- SELECTED EXTERNAL GAL. STEEL STAIR AND GAL.
STEEL HANDRAIL TO PROVIDE ACCESS TO SEWER
MANHOLE - 13 RISERS @ 181mm EACH. TBC PRIOR TO
MANUFACTURE
- TO ENGINEER'S DETAIL


- TYPICAL




NOM. ARCHITECT LAURAN TREVENA 10054






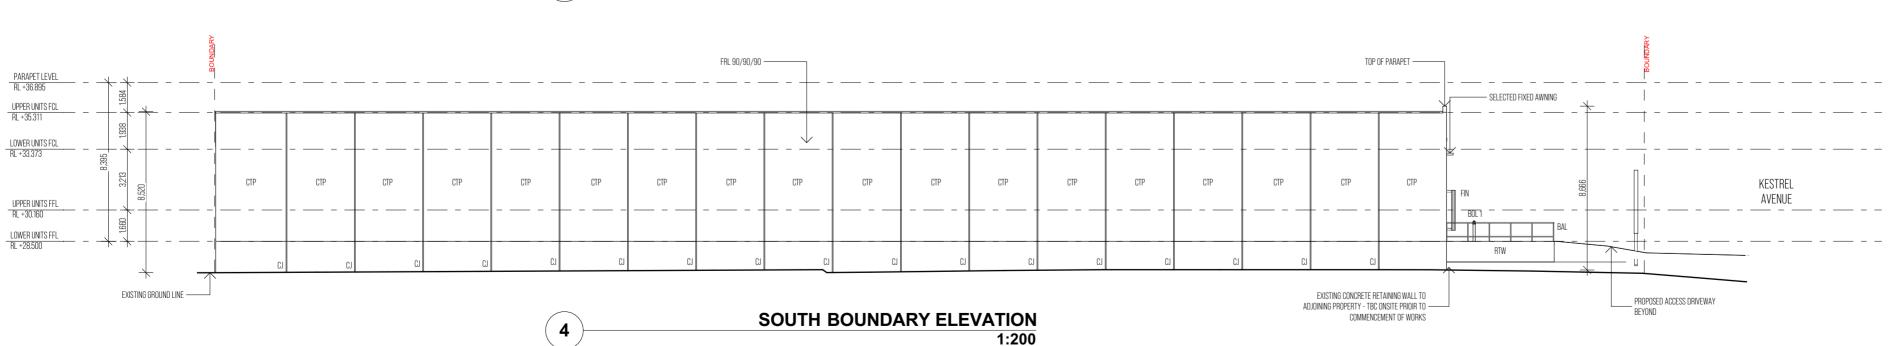


NORTH ELEVATION (INTERNAL) - UNITS 14-19 (3) 1:200

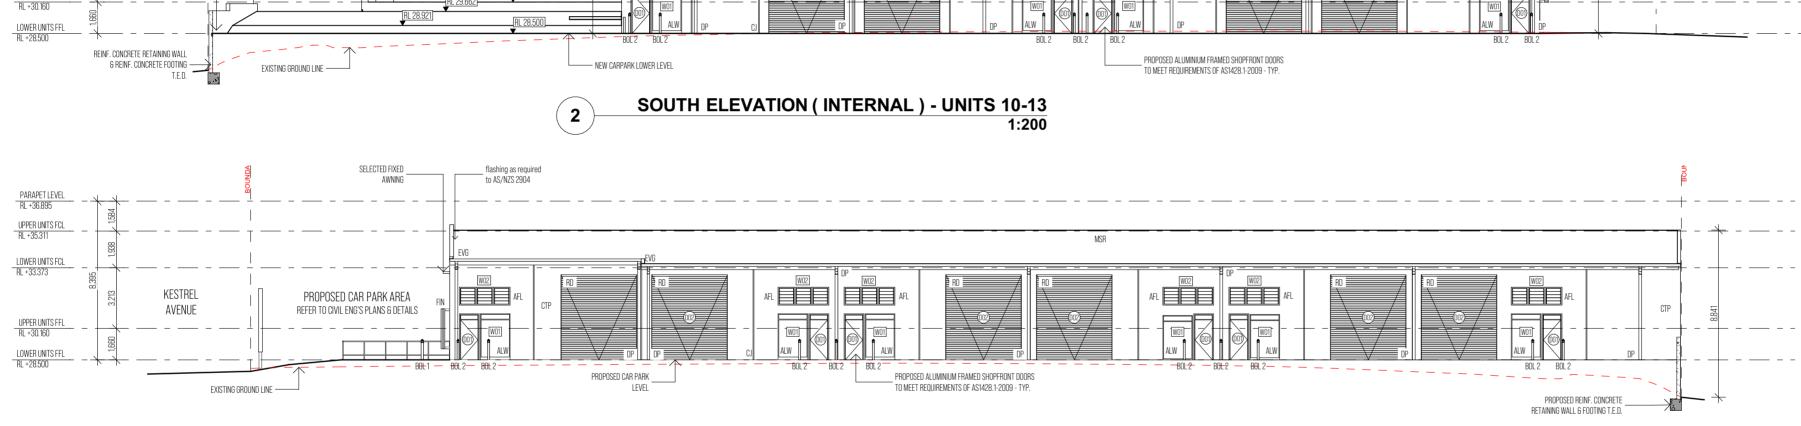

1:200

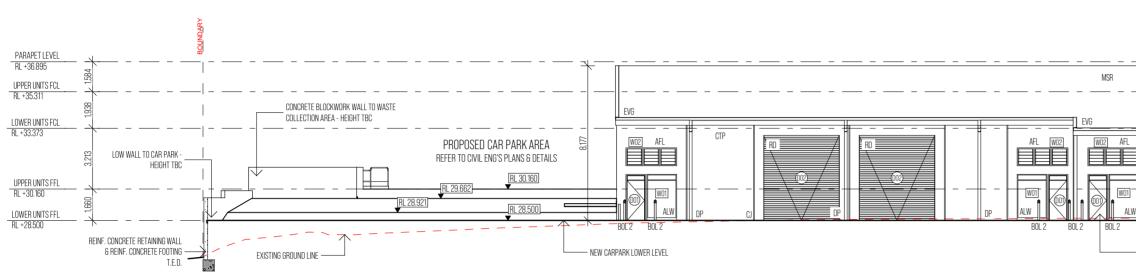

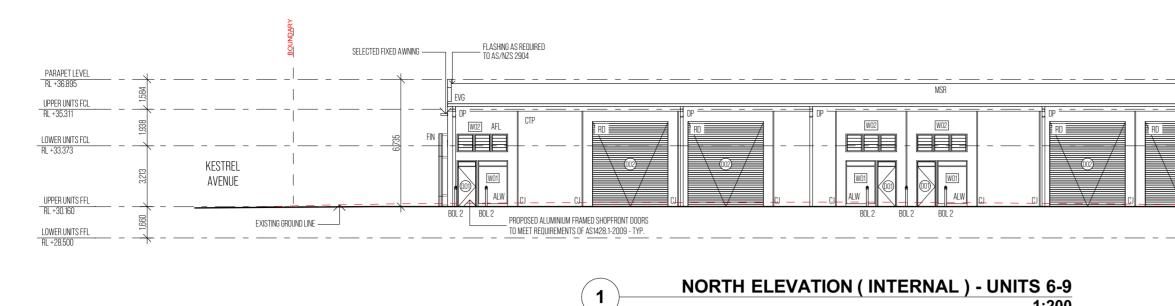

LEGEND

	ALW AFL BAL	- ALUMINIUM FRAMED WINDOW - ALUMINIUM FRAMED LOUVRE WINDOW - SELECTED EXTERNAL BALUTRADE TO MEET
		REQUIREMENTS OF BCA PART 3.9.1
	BOL 1	- SELECTED BOLLARD TO DISABLED CAR PARK SHARED SPACE TO MEET REQUIREMENTS OF AS2890.6 &
	BOL 2	AS1428.1 - Selected Bollard to prevent vehicle blockage of Doorway Circulation space and to Maintain
REFER TO CIVIL ENG'S PLANS & DETAILS		EMERGENCY EGRESS
	CJ	- Control joint
	CTP	- PRECAST CONCRETE TILT-UP PANEL T.E.D.
WALL & REINF. CONCRETE FOOTINGTED.	DP	- SELECTED 150mm Ø DOWNPIPE TO AS/NZS2179.1
— - — - — - — - — - — - — - — - — - — -		& AS/NZS3500.3
	ENG'S	- ENGINEER'S
	EVG	- SELECTED COLRBOND GUTTER TO AS/NZS2179.1
		& AS/NZS3500.3
	FEJ	- FALSE EXPRESSED JOINT - TYPICALLY HORIZONTAL
		JOINTS UNLESS SHOWN OTHERWISE
	FFL	- FINISHED FLOOR LEVEL
	FIN	- SELECTED FIXED LOUVRE FIXED TO STEEL
		STRUCTURAL SUPPRT T.E.D.
flashing as required SELECTED FIXED to AS/NZS 2904 AWNING	FRL	- FIRE RESISTENCE LEVEL
	GAL	- GALVANISED
	KRB	- SELECTED 150mm HIGH CONCRETE KERB
	MSR	- SELECTED CORRUGATED METAL SHEET ROOFING
— - — - — - — - — - — - — - — / + - — - — - — - —	RD	- SELECTED STEEL ROLLER
	REINF.	- REINFORCED
	RTW	- RETAINING WALL T.E.D.
	SBW	- SELECTED SPLIT-FACED CONCRETE BLOCKWORK
	STR	- SELECTED EXTERNAL GAL. STEEL STAIR AND GAL.
		STEEL HANDRAIL TO PROVIDE ACCESS TO SEWER
<mark></mark> ╫╶╢──╶╽ ╴╧╶╱╱╛ ╢ ╴═╲┊╱╛ ╢╴──╶┟╂ _{┉╢} ┠╱╢ ╢──╶╶┼╴╴── _╷ ╴──╶╶──╶╶──╶╶─┤╴──╶╶		MANHOLE - 13 RISERS @ 181mm EACH. TBC PRIOR TO
		MANUFACTURE
	T.E.D.	- TO ENGINEER'S DETAIL
DUL Z DUL Z	TYP.	- TYPICAL

uments, verfy all dimensions on 3. This drawing and the designs licence only for the speopic files/104 - development	02. 11/10/2021	NOTES Schematic Design - Issue A Schematic Design - Issue B Development Application - (for Review)	^{CLIENT} LEVANT INVESTMENT GROUP PTY LTD LOT 602 & 603 KESTREL AVE. THORNTON, NSW	DRAWING TITLE ELEVATIONS	JOB NUMBER 20.21.16	drawn by CS	scale 1:200 @ A2
		DEVELOPMENT APPLICATION - ISSUE A DEVELOPMENT APPLICATION - ISSUE B	PROJECT PROPOSED INDUSTRIAL COMPLEX	DRAWING STATUS DEVELOPMENT APPLICATION - ISSUE B	layout no. A / DAO9	revised by LT	PRINT DATE 25/03/2022