P:

E:

A: 18 Allan St, Lorn, NSW

ABN: <u>73 644 031 461</u> ACN: <u>644 031 461</u>

12 July 2022

Ltd

Re: Proposed changes to 24 King st, East Maitland

To Maitland Council,

The below changes have been made to the approved plans from DA 18/1406:

- 1. Window S-04: In ensuite Unit 1 reduced from 1500 x 1500mm sliding to 600 x 1200 sliding to match Unit 3 main bathroom (East elevation on plan)
- 2. Inground Water tank Unit 2 changed to above ground
- 4. Retaining walls changed from masonry blocks to concrete sleepers
- 5. Lapped and capped fencing FEN-02 to be changed to Colourbond boundary and unit dividing fences or existing colourbond fences to be retained where possible

We propose that the above changes are of minimal environmental impact and the proposed changes are substantially the same as in the development approved in DA 18/1406.

Kind regards,

Miles Wilson I Director

East Elevation Construction Pty Ltd




A single all weather access way will be provided at the front of the property consisting of 50-75 aggregate or similar material at a minimu-thickness of 150 laid over needle-punched geotextile fabric and constructed prior to commencement of works.


The contractor shall ensure that no spoil or fill encroaches upon adjacent areas for the duration of works.

Maintain the above during the course of construction, and clear the

Sediment trap 1000×1000 wide 500 deep pit, located at the lowest point to the trap


Sediment fence

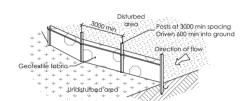


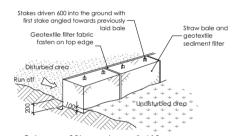

Washout area

Edge board 250 x 50

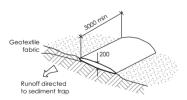

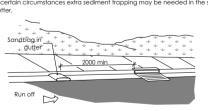

Sediment and erosion control All erosion and sediment control measures to be installed prior to site


Topsoil from all areas that will be disturbed to be stripped and stockpiled at the nominated site.


All sediment control structures to be inspected by site supervisor after each rainfall event for structural damage and all trapped sediment to be removed to a nominated stockpile site.

Sediment fencing shall be secured by post (where metal star pickets are used plastic safely caps shall be used) at 3000 intervals with geotextile fabric embedded 200 in soil.


All topsoil stripped from the site and stockpiled does not interfere with drainage lines and stormwater inlets and will be suitably covered with an impervious membrane material and screened by sediment fencing.

Soil conservation
Prior to commencement of construction provide 'sediment fence,'
'sediment trap' and washout area to ensure the capture of water borne
material generated from the site.

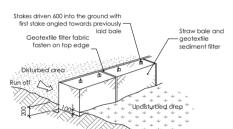

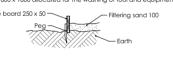

Vehicle access to the building site should be restricted to a single point so as to reduce the amount of soil deposited on the street pavement.

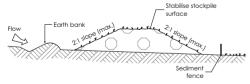

In certain circumstances extra sediment trapping may be needed in the street

FOR CONSTRUCTION

PO Box 601 Kotara NSW 2289 Ph 49524425

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The completion of the issue details checked and authorised section below is conformation of the status of the drawing. The drawing shall not be used for construction unless endorsed 'For Construction" and authorised for issue.



Consultants

AMENDMENT FOR CONSTRUCTION FOR REVISION D FOR REVISION

Description FOR CONSTRUCTION

04-12-18 11-12-18 12-07-22

Project 03-12-18 MULTI DWELLING Location 11-07-22 **24 KING STREET EAST MAITLAND**

COMPASS ADITIONS

3

Drawing SITE PLAN 1:200 @ A2

DRAWN

JD

12/07/2022 QA CHECKED **Drawing Number** A020 C Project Number

17052



(1) 2 3 No. 22 SINGLE STOREY WB DWELLING TILE ROOF PP DP154733 SECONDARY DWELLING CARPORT T1 SMH T2) (A) SITE B.M. WHITE △TOP OF KERB R.L. 20.72 AHD TWO STOREY BK DWELLING TILE ROOF (B) DWELLING UNIT 1 FFL 19,970 FFL 19,970 UNIT 2 UNIT 3 FFL 19,970 S WATERMAIN NOT LOCATED BY SURVEY 121 G DP573023 ---VEHICLE PASSING BAY DP997967 1015m² VEHICLE CROSSING TO MATCH DRIVEWAY STRIPS MORPETH MIX DRIVEWAY STRIPS WITH LAWN INFILL AS OUTLINED IN THE DA CONSENT SOP BOUNDARY FENCE SITE BOUNDARY 50 44 GARAGE SINGLE STOREY BK DWELLING TILE ROOF No. 26 SINGLE STOREY WB DWELLING METAL ROOF GROUP STYLE LETTER BOX TO AUST. POST STANDARDS DP997967 12,200 2 (1)

LEGEND

4,000 LITRE ABOVE GROUND WATER STORAGE TANK TO ENGINEERS AND BASIX DETAILS

T2 4,000 LITRE ABOVE UNDER GROUND WATER STORAGE TANK TO ENGINEERS AND BASIX DETAILS

RW RETAINING WALLS TO ENGINEERS SPECIFICATIONS & DETAILS

BUILDING FOOTPRINT

EXISTING BUILDING FOOTPRINT

STORMWATER PIT

NOTES

FOR STORMWATER DETAILS REFER TO CONSULTING ENGINEERS DOCUMENTATION


STORMWATER DOCUMENTATION MUST COMPLY WITH CONDITIONS 25-29 OF THE DA CONSENT


FOR ROADWAY, DRIVEWAY AND RETAINING WALL DESIGN & LEVELS REFER TO CIVIL ENGINEERS DOCUMENTATION

VERTICAL CONTROL JOINTS
INDICATIVE ONLY LOCATED IN ALL
EXTERNAL WALLS 5000-6000mm
CTS MAX AS PER ENGINEERS
SPECIFICATIONS TO AS/NZS 4773.2
& TN 61.(BUILDER TO CONFIRM
LOCATIONS)

FOR LANDSCAPE DESIGN REFER TO APPROVED LANDSCAPE DESIGN DOCUMENTATION

ALL BUILDING WORK TO BE CARRIED OUT IN ACCORDANCE WITH THE PROVISIONS OF THE BUILDING CODE OF AUSTRALIA

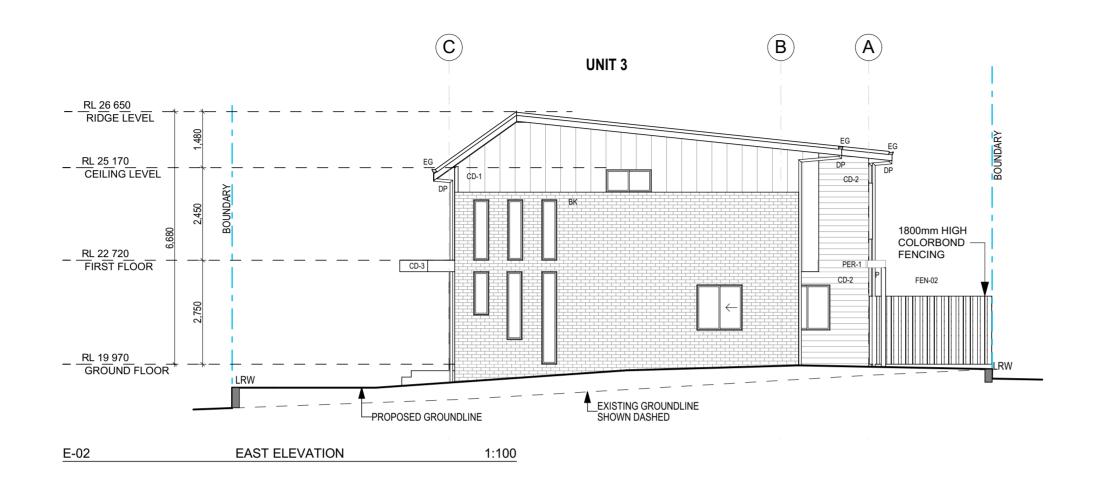

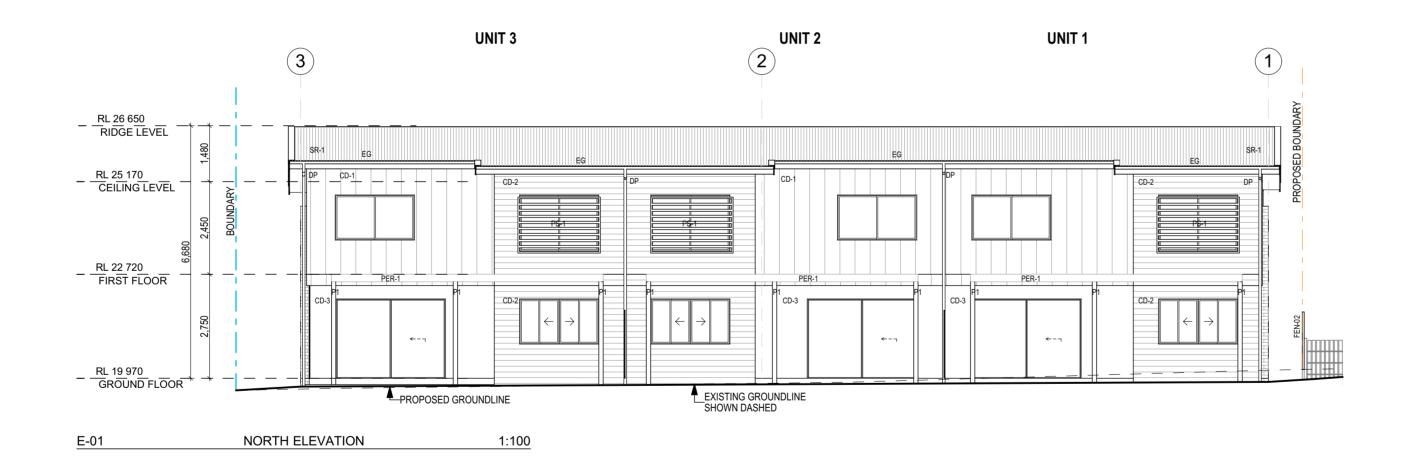


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18	Project MULTI DWELLING
18 18 22	Location 24 KING STREET EAST MAITLAND
	Client COMPASS ADITIONS


Drawing ELEVATIONS	
Scale 1:100 @ A2	
DRAWN	


12/07/2022

QA CHECKED

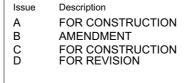Drawing Number
A300
Issue
C
Project Number
17052



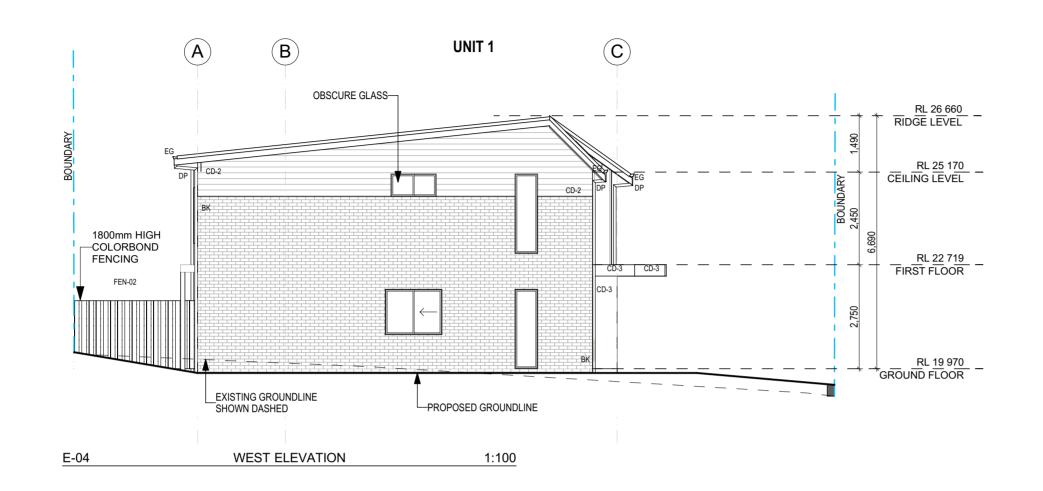

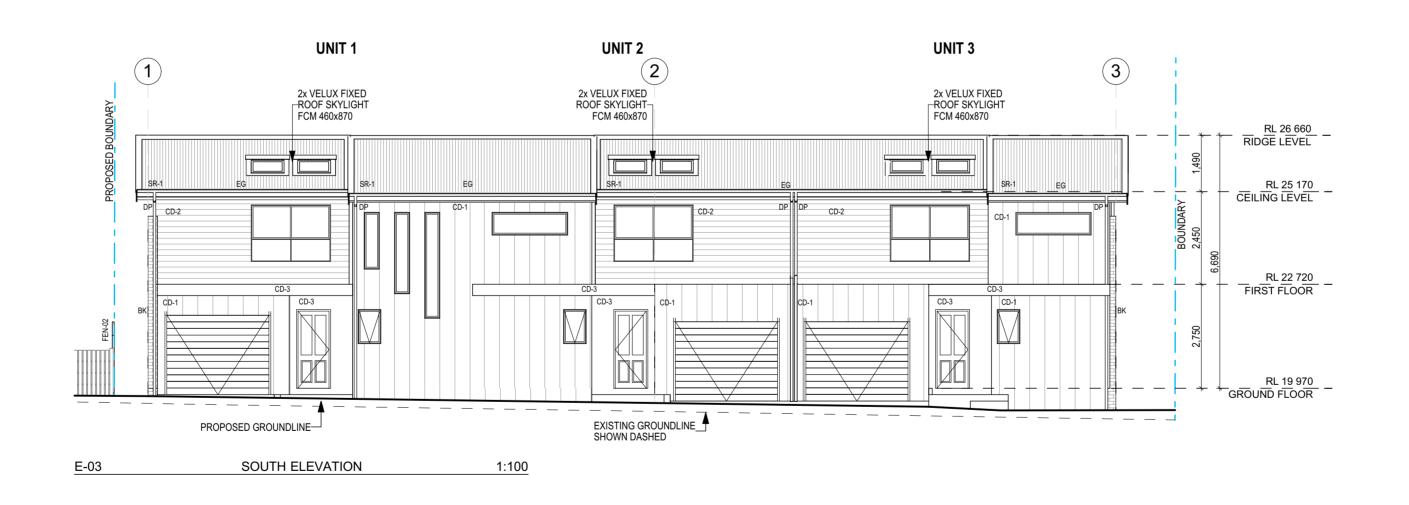

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A FOR CONSTRUCTION
B AMENDMENT
C FOR CONSTRUCTION
D FOR REVISION

	Date
I	03-12-18
	04-12-18
I	11-12-18
	11-07-22

Project
MULTI DWELLING
Location
24 KING STREET
EAST MAITLAND
Client
COMPASS ADITIONS

Drawing ELEVATIONS
Scale 1:100 @ A2
DRAWN

JD

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	A3
Date 12/07/2022	lssue C
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